# PROPOSED SITE DEVELOPMENT PLANS

**PROPOSED** 

RESTAURANT W/ DRIVE-THRU

**LOCATION OF SITE** 


494 LINCOLN STREET, CITY OF WORCESTER WORCESTER COUNTY, MASSACHUSETTS

MAP 39, BLOCK 29, LOT 1C

## REFERENCES AND CONTACTS

REFERENCES ♦BOUNDARY & TOPOGRAPHIC SURVEY: 352 TURNPIKE ROAD SOUTHBOROUGH, MA 01772 DATED: 05/23/24 JOB #03-240145-00 **ELEVATIONS: NAVD 1988** MANCHESTER, NH 05/23/24 ♦PHOTOMETRIC SITE PLAN ADA ARCHITECTS 17710 DETROIT AVENUE DATED: 10/01/24

THE ABOVE REFERENCED DOCUMENTS ARE INCORPORATED BY REFERENCE AS PART OF THESE PLANS. ACCURACY OF THE WORK REFERENCED OR DERIVED FROM THESE DOCUMENTS, BY OTHERS.

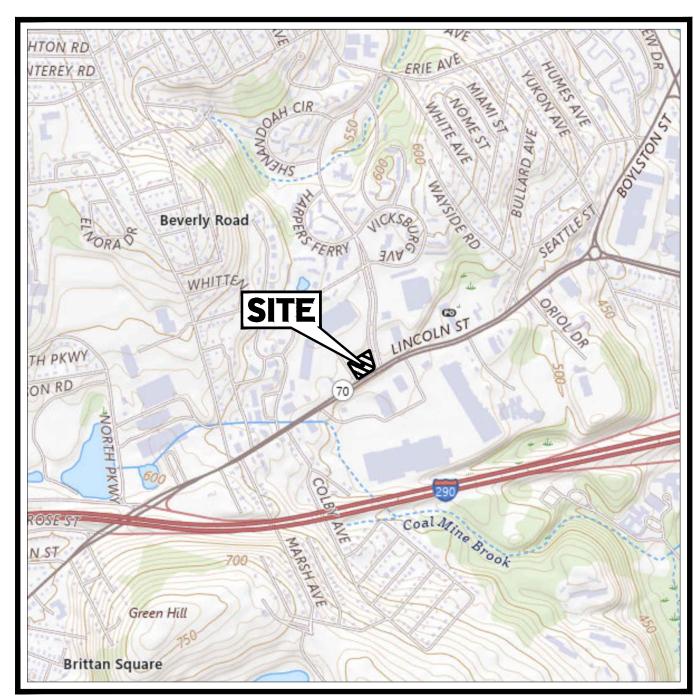

**USGS MAP** 

SCALE: 1" = 1,000' SOURCE: WORCESTER NORTH USGS QUADRANGLE





**AERIAL MAP** 

SOURCE: GOOGLE EARTH



**DEVELOPER** (972)-769-3206

PREPARED BY





REVISIONS				
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DOCUMENT UNLESS	S INDICATED OTHERWISE.
PROJECT No.:	MAA240136
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CHECKED BY:	M
DATE:	10/03/20
CAD I.D.:	X-CIVL-T1

**SHEET INDEX** 

SHEET NUMBER

C-101

C-102

C-401

C-803

C-901

C-902

C-903

C-904

L-101

L-102

1 OF 1

**SHEET TITLE** 

**COVER SHEET** 

**GRADING PLAN** 

GENERAL NOTES AND LEGEND

DIMENSION CONTROL PLAN

UTILITY & DRAINAGE PLAN

CONSTRUCTION DETAILS

CONSTRUCTION DETAILS

CONSTRUCTION DETAILS

CONSTRUCTION DETAILS

LANDSCAPE NOTES AND DETAILS

PHOTOMETRIC SITE PLAN (BY OTHERS)

ALTA/NSPS LAND TITLE SURVEY (BY OTHERS)

LANDSCAPE PLAN

EXISTING CONDITIONS/DEMOLITION PLAN

**EROSION AND SEDIMENT CONTROL PLAN** 

EROSION AND SEDIMENT CONTROL NOTES AND DETAILS

## SITE DEVELOPMENT **PLANS**

PROPOSED DEVELOPMENT

MAP: 39 | BLK: 29 | LOT: 1C **494 LINCOLN STREET WORCESTER COUNTY** WORCESTER, MASSACHUSETTS


PROTOTYPE 6-V-AV **RESTAURANT #RC1233** 

**DESIGNER INFORMATION:** 



352 TURNPIKE ROAD, 3rd FLOOR SOUTHBOROUGH, MA 01772

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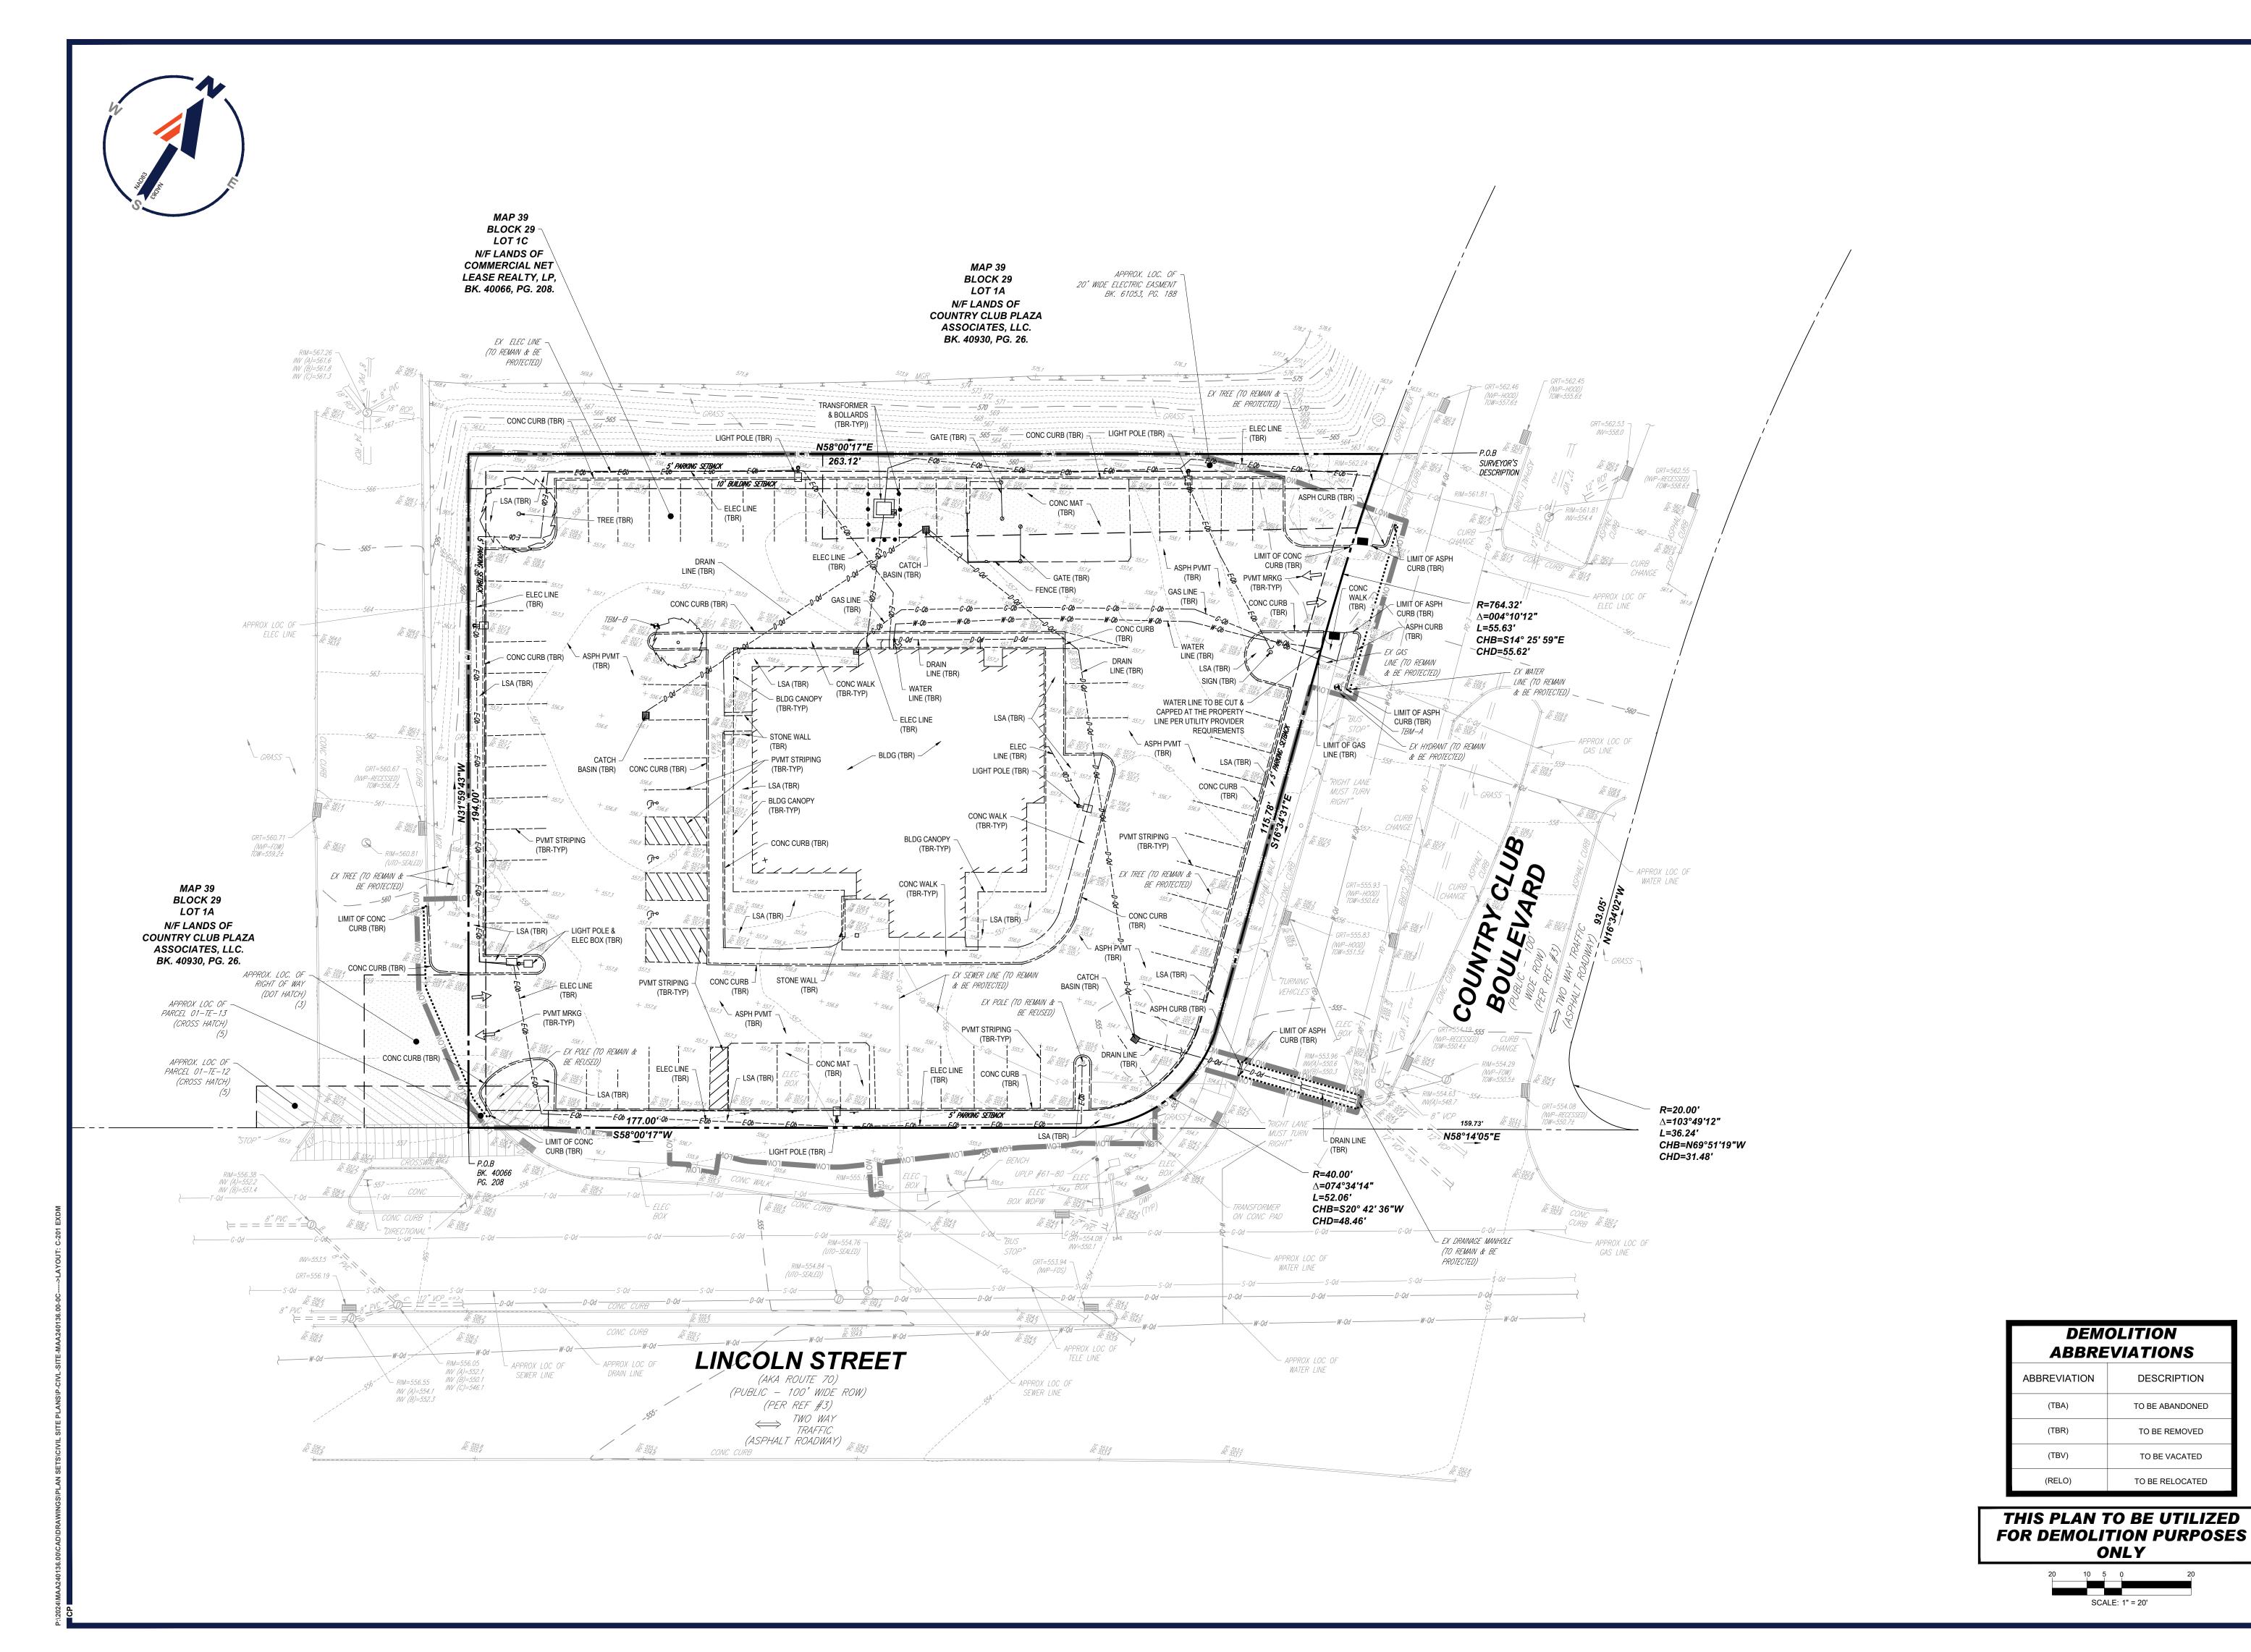


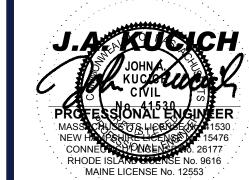COVER SHEET

C-101

**REVISION 1 - 10/22/2024** 

IT IS THE RESPONSIBILITY OF THE CONTRACTOR TO REVIEW ALL OF THE DRAWINGS AND SPECIFICATIONS ASSOCIATED WITH THIS PROJECT VORK SCOPE PRIOR TO THE INITIATION OF CONSTRUCTION. SHOULD THE CONTRACTOR FIND A CONFLICT WITH THE DOCUMENTS RELATIVE THE SPECIFICATIONS OR APPLICABLE CODES, IT IS THE CONTRACTOR'S RESPONSIBILITY TO NOTIFY THE PROJECT ENGINEER OF RECORD II VRITING PRIOR TO THE START OF CONSTRUCTION. FAILURE BY THE CONTRACTOR TO NOTIFY THE PROJECT ENGINEER SHALL CONSTITUT





Restaurant Support Office 6800 Bishop Road, Plano, TX 75024 Tele: 972-769-3100 Fax: 972-769-310

PROTOTYPE ISSUE DATE:

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DATE: CAD I.D.:

## SITE DEVELOPMENT **PLANS**

PROPOSED DEVELOPMENT

MAP: 39 | BLK: 29 | LOT: 1C 494 LINCOLN STREET WORCESTER COUNTY **WORCESTER, MASSACHUSETTS** 

**DEMOLITION ABBREVIATIONS** 

ONLY

SCALE: 1" = 20'

DESCRIPTION

TO BE ABANDONED

TO BE REMOVED

TO BE VACATED

TO BE RELOCATED

PROTOTYPE 6-V-AV **RESTAURANT #RC1233** 

**DESIGNER INFORMATION:** 

352 TURNPIKE ROAD, 3rd FLOOR SOUTHBOROUGH, MA 01772 Phone: (508) 480-9900


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**EXISTING CONDITIONS DEMOLITION PLAN** 

SHEET NUMBER:

C-201



ONLY

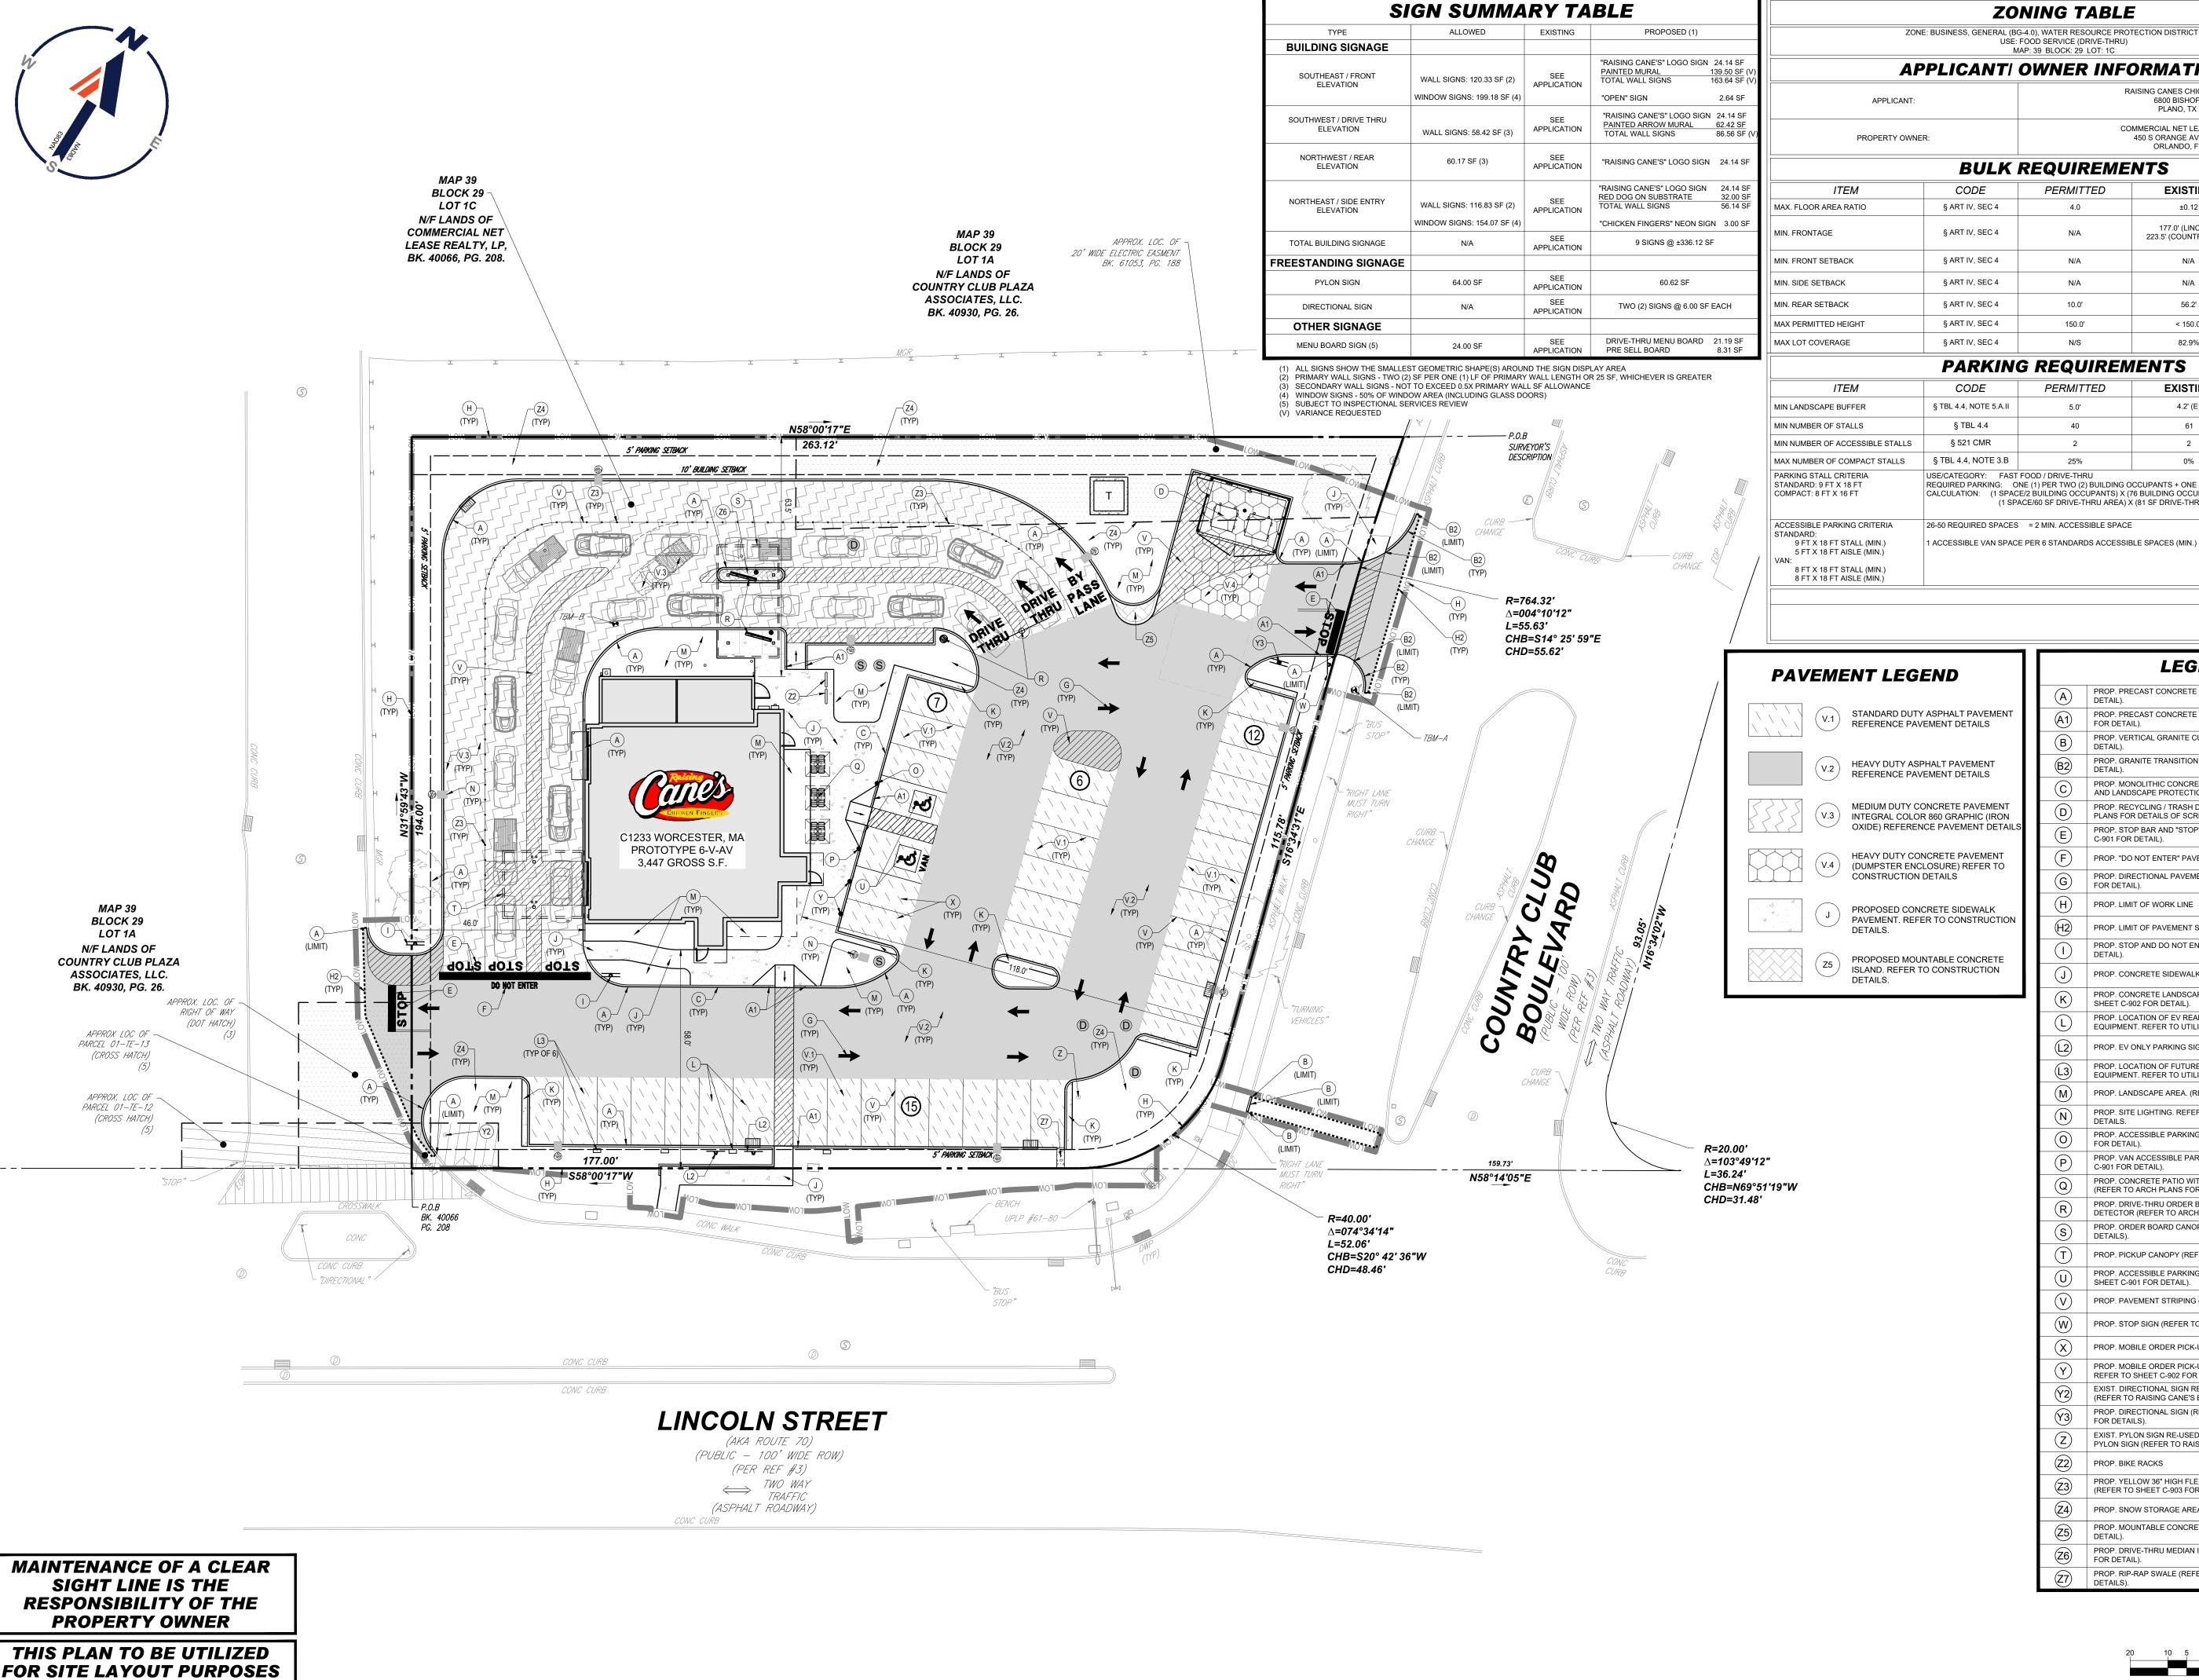**ZONING TABLE** ZONE: BUSINESS, GENERAL (BG-4.0), WATER RESOURCE PROTECTION DISTRICT (GP-3) USE: FOOD SERVICE (DRIVE-THRU) MAP: 39 BLOCK: 29 LOT: 1C APPLICANTI OWNER INFORMATION RAISING CANES CHICKEN FINGERS 6800 BISHOP ROAD PLANO, TX 75024 COMMERCIAL NET LEASE REALTY, LP 450 S ORANGE AVE, SUITE 900 ORLANDO, FL 32801

BULK REQUIREMENTS					
ITEM	CODE	PERMITTED	EXISTING	PROPOSED	
MAX. FLOOR AREA RATIO	§ ART IV, SEC 4	4.0	±0.12	±0.06	
MIN. FRONTAGE	§ ART IV, SEC 4	N/A	177.0' (LINCOLN) 223.5' (COUNTRY CLUB)	NO CHANGE	
MIN. FRONT SETBACK	§ ART IV, SEC 4	N/A	N/A	N/A	
MIN. SIDE SETBACK	§ ART IV, SEC 4	N/A	N/A	N/A	
MIN. REAR SETBACK	§ ART IV, SEC 4	10.0'	56.2'	63.5'	
MAX PERMITTED HEIGHT	§ ART IV, SEC 4	150.0'	< 150.0'	< 150.0'	
MAX LOT COVERAGE	§ ART IV, SEC 4	N/S	82.9%	78.5%	

X EOT COVERAGE	g AITT IV, OLO 4	14/3	62.970	76.5%		
PARKING REQUIREMENTS						
ITEM	CODE	PERMITTED	EXISTING	PROPOSED		
I LANDSCAPE BUFFER	§ TBL 4.4, NOTE 5.A.II	5.0'	4.2' (E)	5.0'		
NUMBER OF STALLS	§ TBL 4.4	40	61	40		
NUMBER OF ACCESSIBLE STALLS	§ 521 CMR	2	2	2		
X NUMBER OF COMPACT STALLS	§ TBL 4.4, NOTE 3.B	25%	0%	30%		
RKING STALL CRITERIA ANDARD: 9 FT X 18 FT MPACT: 8 FT X 16 FT	REQUIRED PARKING: O CALCULATION: (1 SPAC	E/2 BÚILDING OCCUPANTS) X (7	CCUPANTS + ONE (1) PER 60 SF 76 BUILDING OCCUPANTS) = 37 (81 SF DRIVE-THRU AREA) = 2	.5 SPACES		

KEY = SPECIAL PERMIT REQUIR (E) - EXISTING NONCONFORMANCE

(N/A) - NOT APPLICABLE LEGEND

REFERENCE PAVEMENT DETAILS HEAVY DUTY ASPHALT PAVEMENT REFERENCE PAVEMENT DETAILS

(DUMPSTER ENCLOSURE) REFER TO PROPOSED CONCRETE SIDEWALK PAVEMENT. REFER TO CONSTRUCTION

PROP. PRECAST CONCRETE TRANSITION CURB (REFER TO SHEET C-90 PROP. VERTICAL GRANITE CURB (REFER TO SHEET C-901 FOR It's fast. It's free. It's the law. PROP. MONOLITHIC CONCRETE CURB (REFER TO CONCRETE SIDEWALK AND LANDSCAPE PROTECTION STRIP DETAIL ON SHEET C-901). PROP. RECYCLING / TRASH DUMPSTER LOCATION /REFER TO ARCH PLANS FOR DETAILS OF SCREENING GATES BOLLARDS AND FINISHES PROP. STOP BAR AND "STOP" PAVEMENT MARKING (REFER TO SHEET C-901 FOR DETAIL). PROP. "DO NOT ENTER" PAVEMENT MARKINGS PROJECT No.: DRAWN BY:

PROP. DIRECTIONAL PAVEMENT MARKING (REFER TO SHEET C-903

PROP. LIMIT OF WORK LINE PROP. LIMIT OF PAVEMENT SAWCUT LINE PROP. STOP AND DO NOT ENTER SIGN (REFER TO SHEET C-901 FOR

DETAIL). PROP. CONCRETE SIDEWALK (REFER TO SHEET C-901 FOR DETAIL) PROP. CONCRETE LANDSCAPE PROTECTION STRIP (REFER TO

PROP. PRECAST CONCRETE CURB (REFER TO SHEET C-901 FOR

SHEET C-902 FOR DETAIL). PROP. LOCATION OF EV READY PARKING SPACE AND ASSOCIATED EQUIPMENT. REFER TO UTILITY PLAN (SHEET C-501).

PROP. EV ONLY PARKING SIGN (REFER TO SHEET C-901 FOR DETAIL). PROP. LOCATION OF FUTURE EV PARKING SPACE AND ASSOCIATED EQUIPMENT. REFER TO UTILITY PLAN (SHEET C-501). PROP. LANDSCAPE AREA. (REFER TO SHEET L-101 FOR DETAILS). PROP. SITE LIGHTING. REFER TO LIGHTING PLANS BY OTHERS FOR

DETAILS. PROP. ACCESSIBLE PARKING SIGN IN BOLLARD (REFER TO SHEET C-90 FOR DETAIL) PROP. VAN ACCESSIBLE PARKING SIGN IN BOLLARD (REFER TO SHEET

C-901 FOR DETAIL). PROP. CONCRETE PATIO WITH CANOPY AND OUTDOOR SEATING (REFER TO ARCH PLANS FOR DETAILS). PROP. DRIVE-THRU ORDER BOARD, PRE-ORDER OR HEIGHT DETECTOR (REFER TO ARCH PLANS FOR DETAILS). PROP. ORDER BOARD CANOPY (REFER TO ARCH PLANS FOR

PROP. PICKUP CANOPY (REFER TO ARCH PLANS FOR DETAILS). PROP. ACCESSIBLE PARKING SPACES AND STRIPING (REFER TO SHEET C-901 FOR DETAIL).

PROP. PAVEMENT STRIPING (REFER TO ARCH PLANS FOR DETAILS) PROP. STOP SIGN (REFER TO SHEET C-901 FOR DETAIL).

PROP. MOBILE ORDER PICK-UP PARKING SPACES (TYP. OF 2) PROP. MOBILE ORDER PICK-UP SIGNS IN BOLLARD (TYP. OF 2). REFER TO SHEET C-902 FOR DETAIL. EXIST. DIRECTIONAL SIGN RE-USED FOR PROP. DIRECTIONAL SIGN


(REFER TO RAISING CANE'S BRAND BOOK FOR DETAILS). EXIST. PYLON SIGN RE-USED FOR PROP. INTERNALLY ILLUMINATED

PYLON SIGN (REFER TO RAISING CANE'S BRAND BOOK FOR DETAILS). PROP. BIKE RACKS

PROP. YELLOW 36" HIGH FLEXIBLE DELINEATORS PLACED 4' O.C. (REFER TO SHEET C-903 FOR DETAIL).

(Z4) PROP. SNOW STORAGE AREA PROP. MOUNTABLE CONCRETE ISLAND (REFER TO SHEET C-902 FOR

PROP. DRIVE-THRU MEDIAN ISLAND PAVERS (REFER TO SHEET C-903 FOR DETAIL). PROP. RIP-RAP SWALE (REFER TO SHEET C-401 AND C-903 FOR

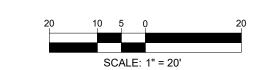



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PROTOTYPE ISSUE DATE:

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PROJECT:

## SITE DEVELOPMENT **PLANS**

PROPOSED DEVELOPMENT

MAP: 39 | BLK: 29 | LOT: 1C **494 LINCOLN STREET WORCESTER COUNTY** WORCESTER, MASSACHUSETTS

PROTOTYPE 6-V-AV **RESTAURANT #RC1233** 

**DESIGNER INFORMATION:** 

352 TURNPIKE ROAD, 3rd FLOOR SOUTHBOROUGH, MA 01772 Phone: (508) 480-9900


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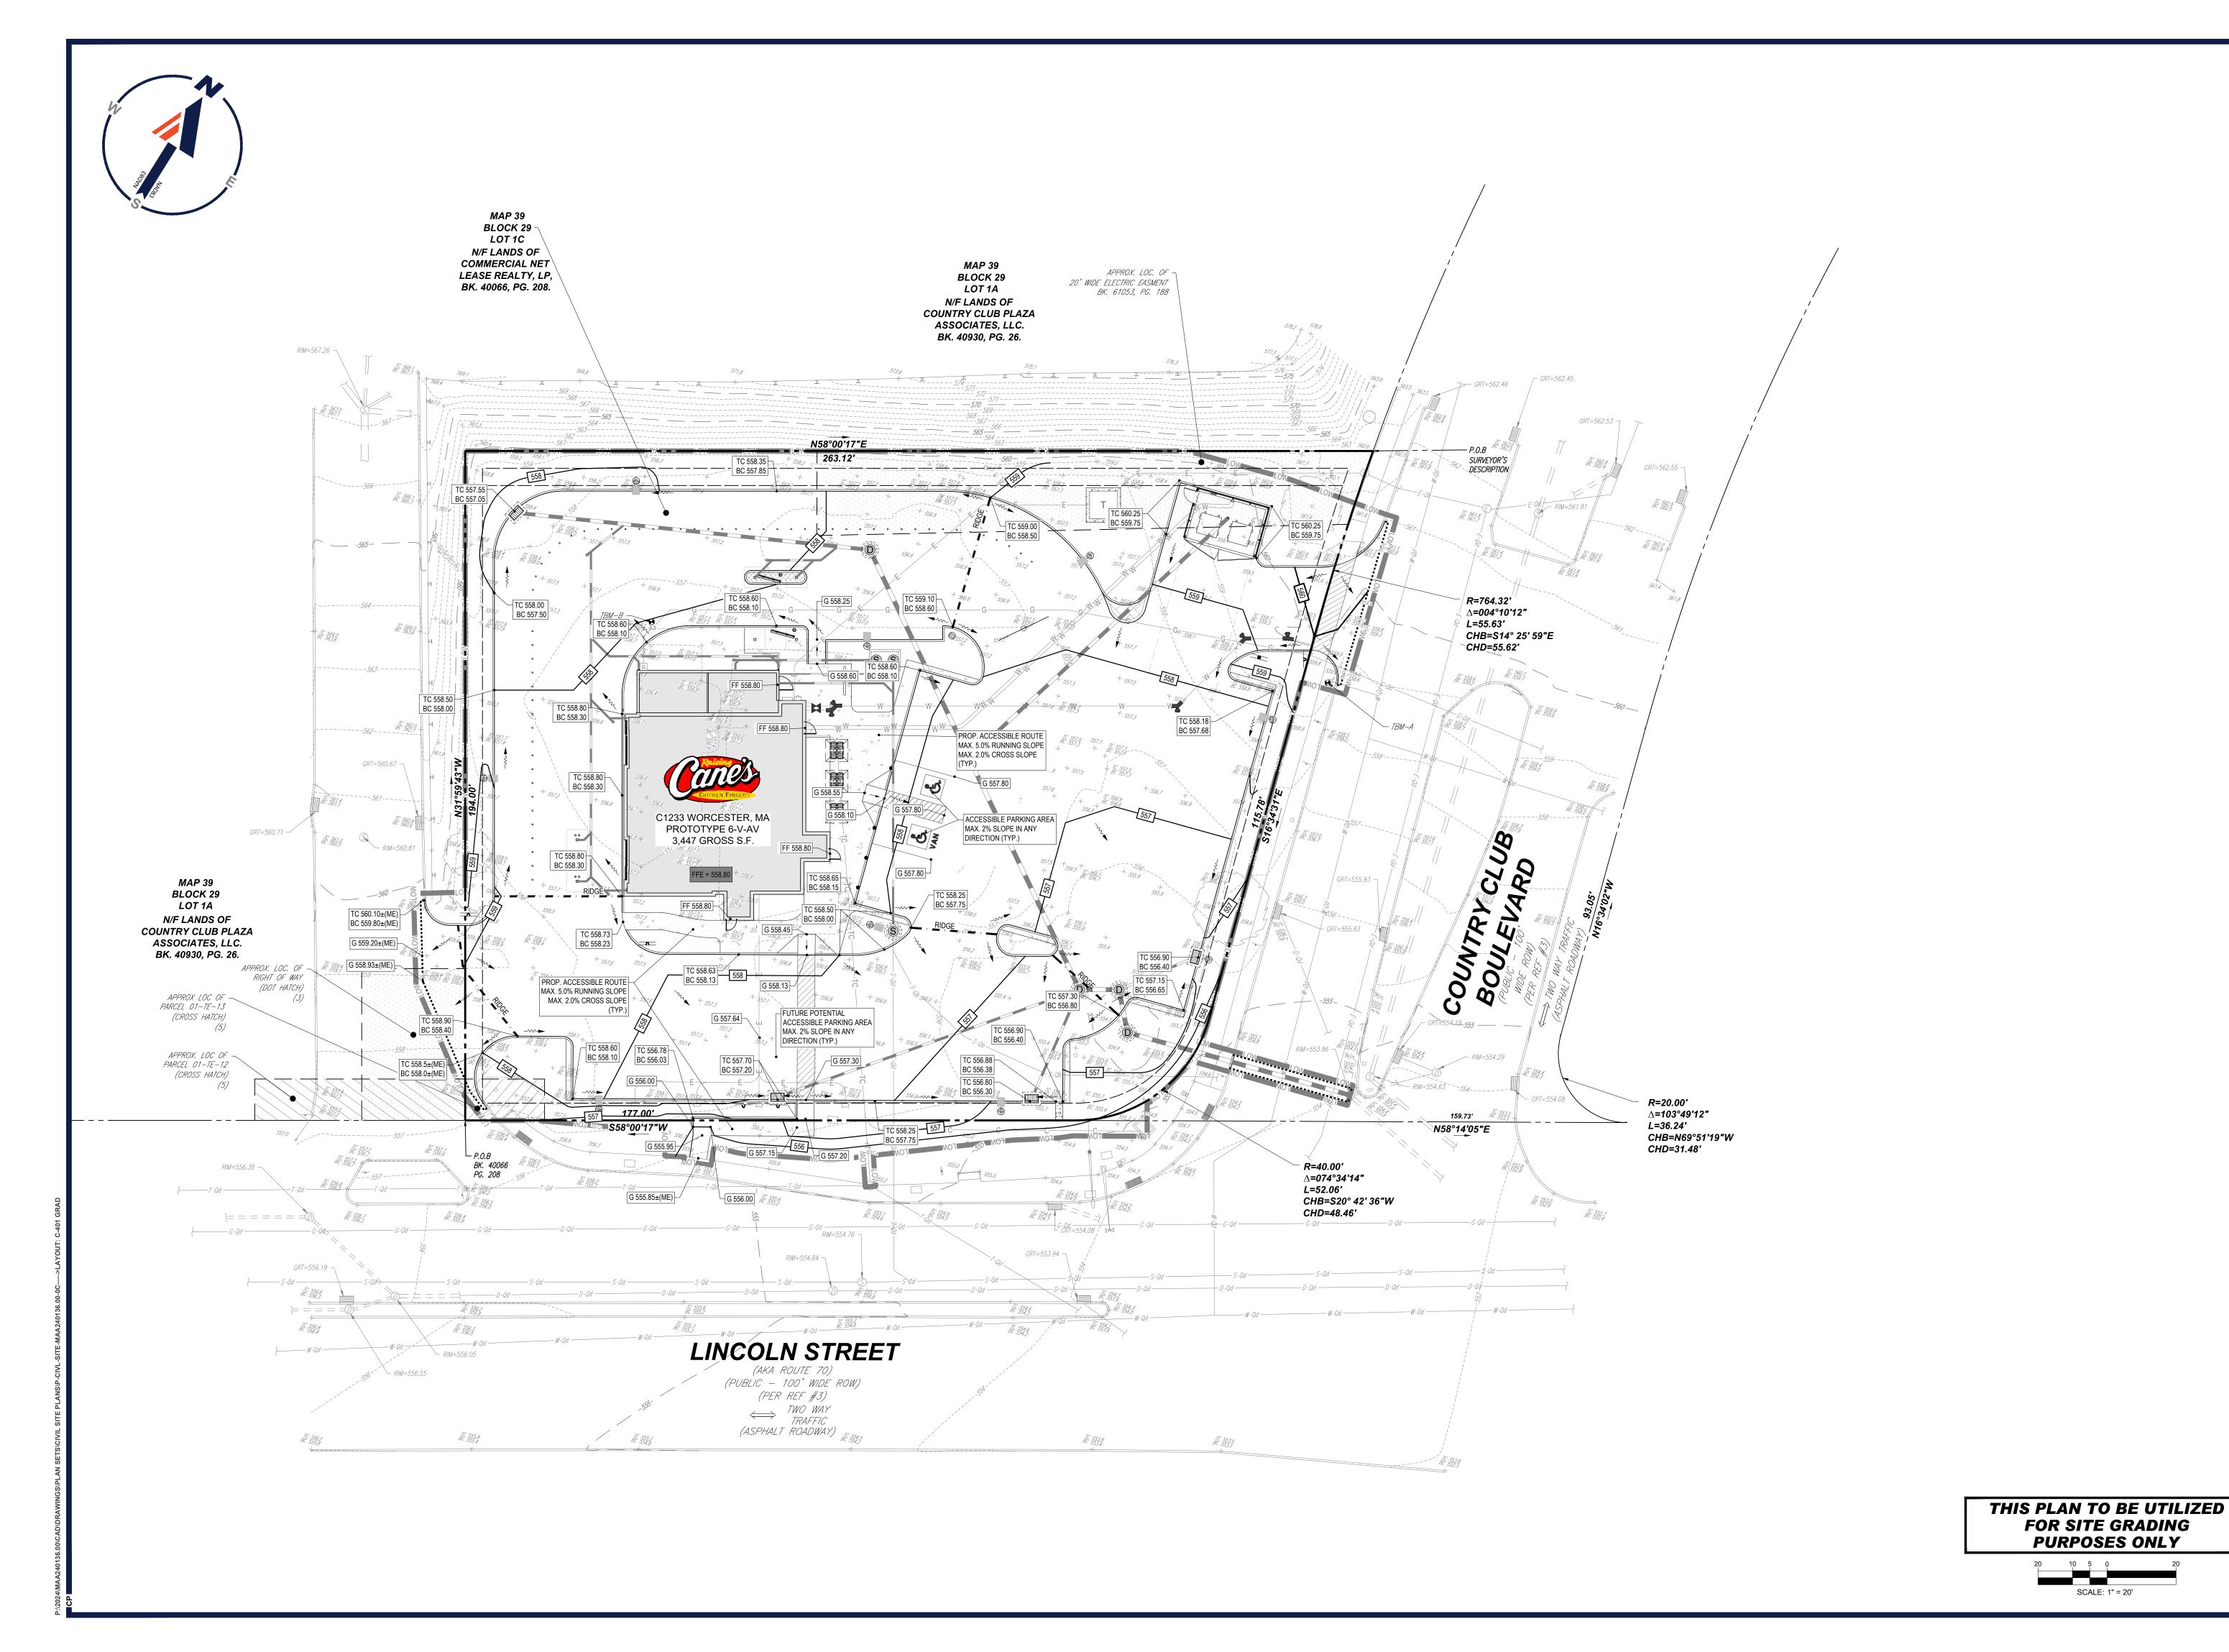


SHEET TITLE:

SITE **PLAN** 

C-301



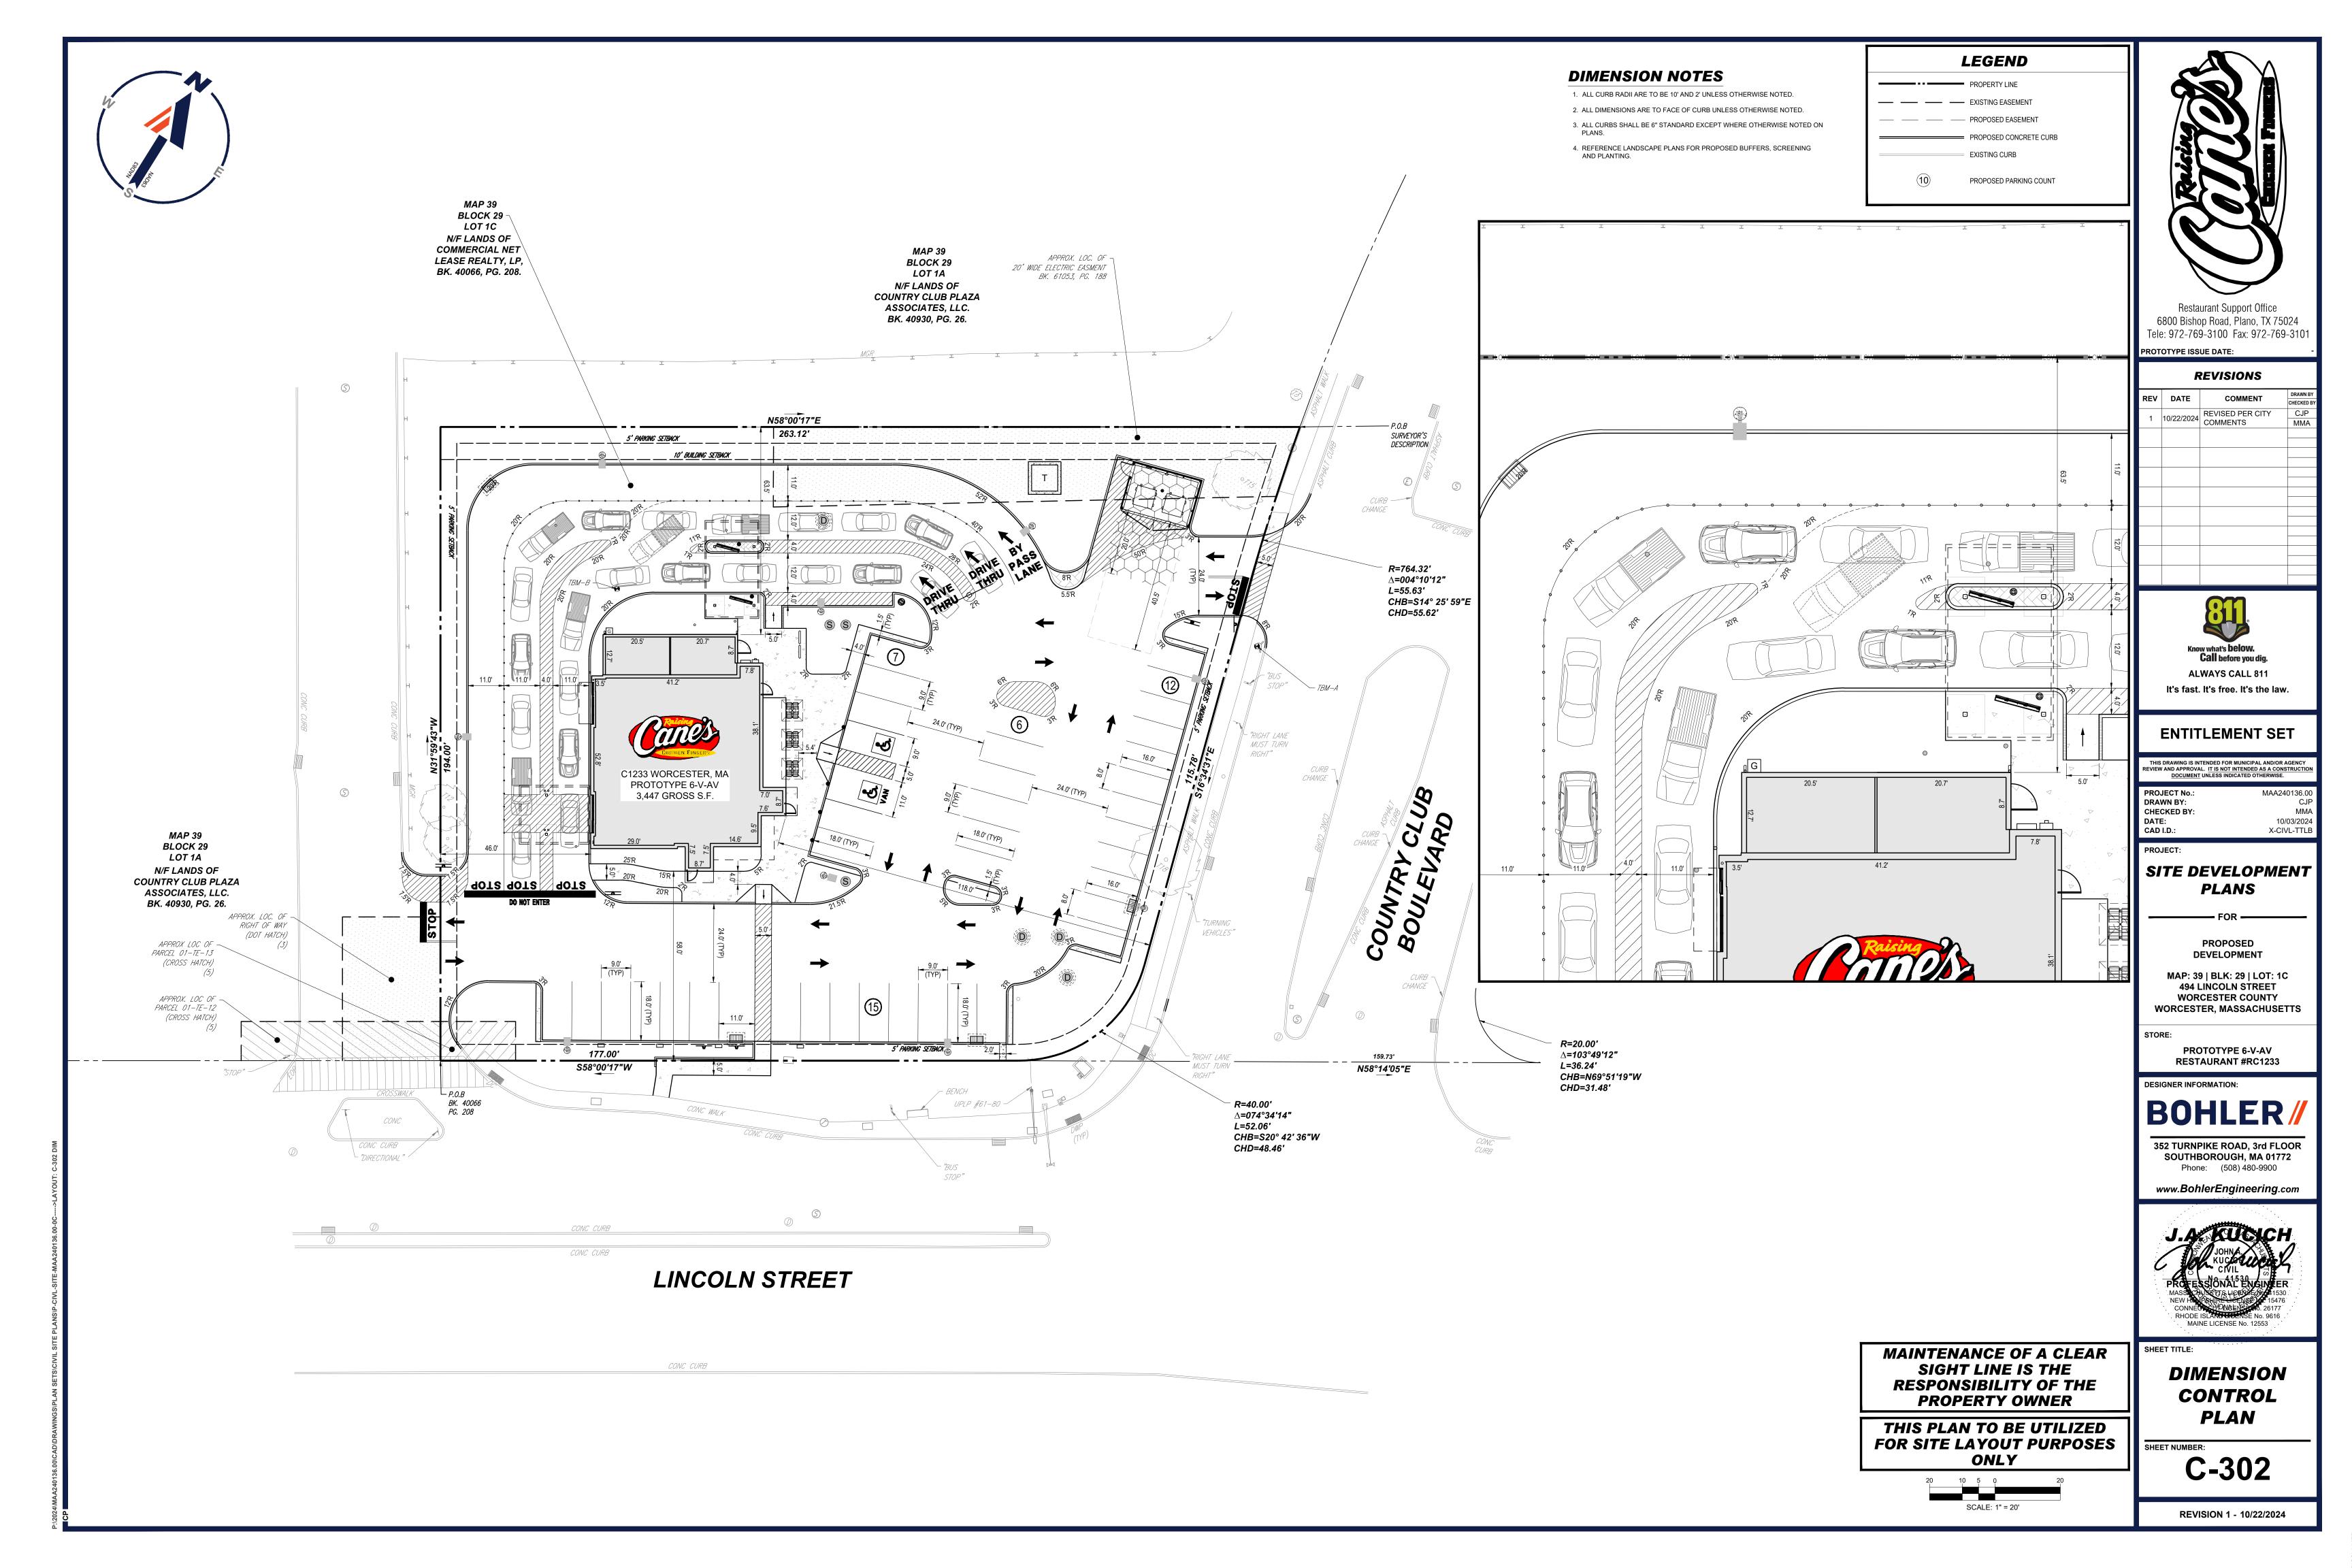



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## SITE DEVELOPMENT **PLANS**

PROPOSED DEVELOPMENT

MAP: 39 | BLK: 29 | LOT: 1C **494 LINCOLN STREET** WORCESTER COUNTY **WORCESTER, MASSACHUSETTS** 

PROTOTYPE 6-V-AV **RESTAURANT #RC1233** 

**DESIGNER INFORMATION:** 

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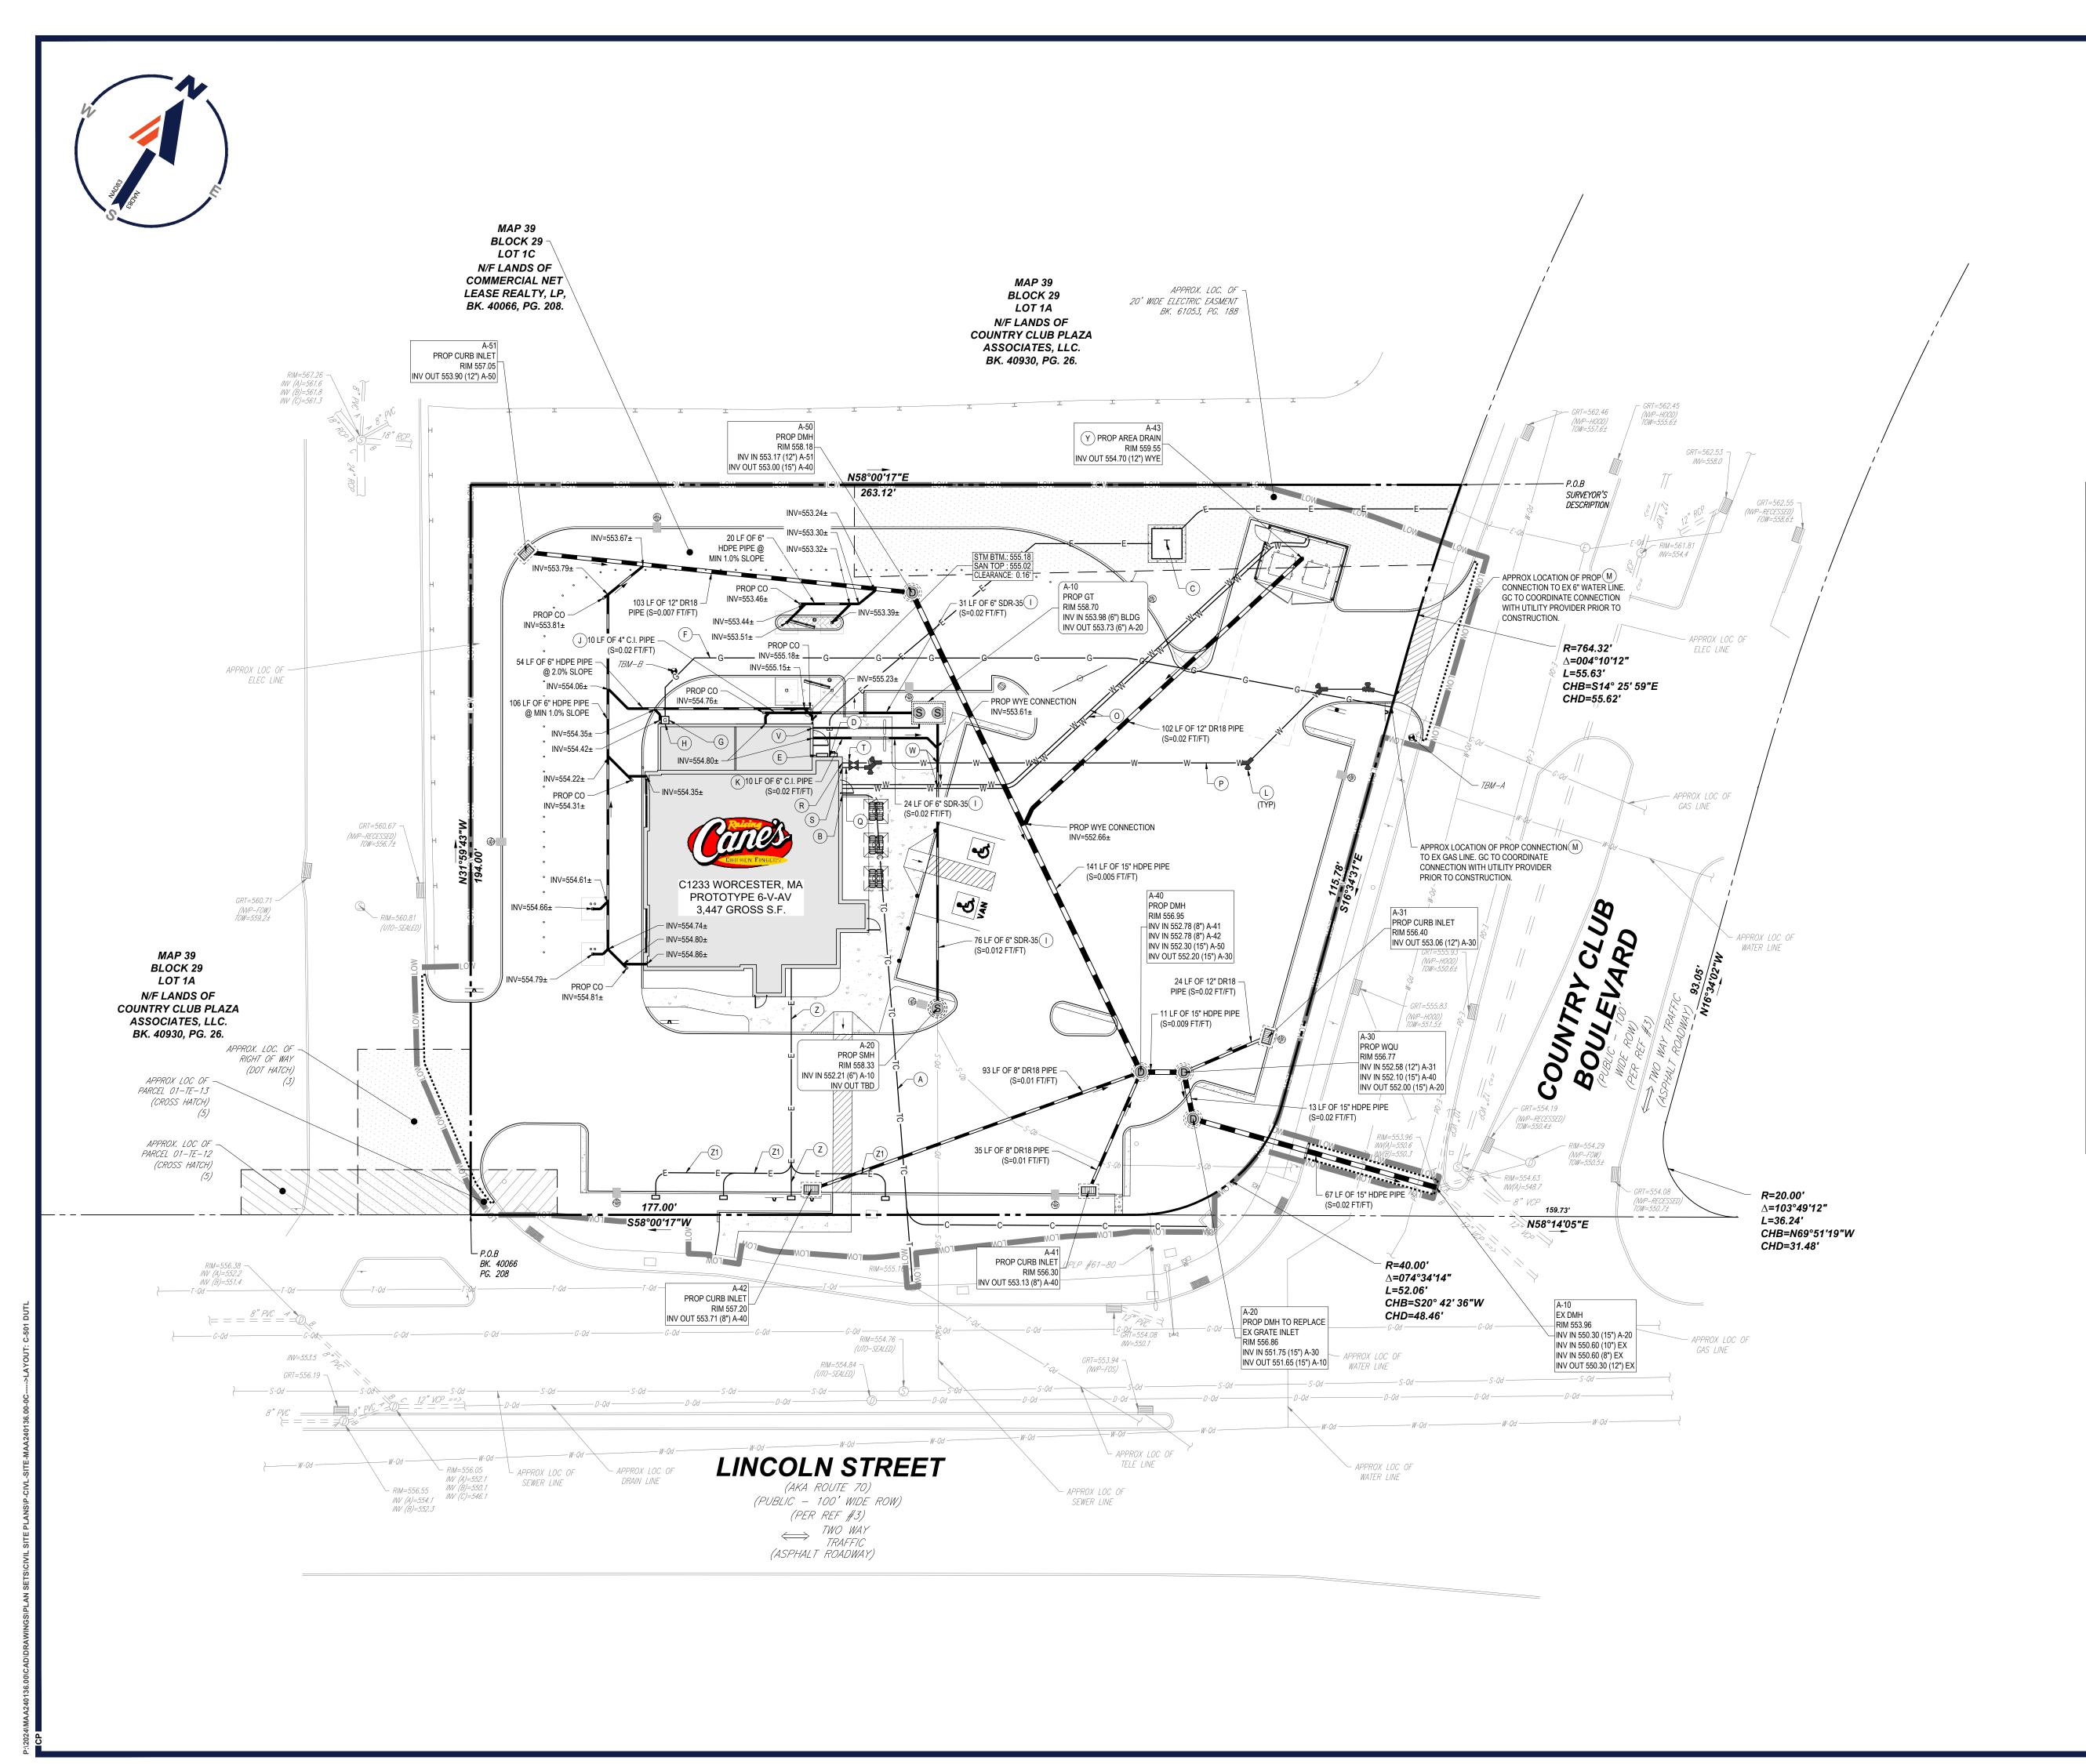



SHEET TITLE:

**GRADING** PLAN

SCALE: 1" = 20'

C-401



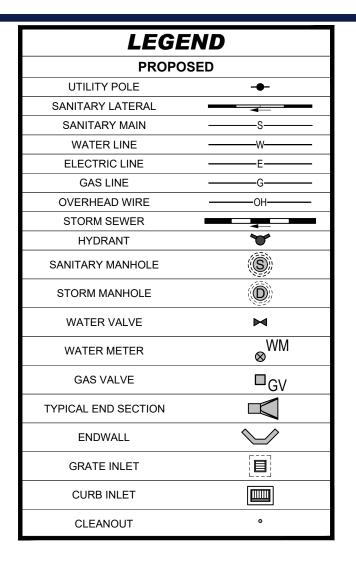

		<b>.</b>
U	TILITY KEYNOTE LEGEND	
A	INSTALL 4" PVC CONDUIT FOR TELEPHONE AND 3" PVC CONDUIT FOR INTERNET.	
В	PROP. TELEPHONE AND INTERNET ENTRY. REFERENCE ARCHITECTURAL PLANS FOR CONTINUATION.	
C	PROP. TRANSFORMER MOUNTED ON CONCRETE PAD. GC TO COORDINATE BOLLARD PROTECTION AND INSTALLATION WITH UTILITY PROVIDER. REFERENCE TO MEP PLANS FOR CONTINUATION.	
D	PROP. ELECTRIC SERVICE ENTRY WITH METER. REFERENCE ARCHITECTURAL / MEP PLANS FOR CONTINUATION.	
E	PROP. ELECTRIC SWITCHGEAR. REFERENCE ARCHITECTURAL / MEP PLANS.	
F	PROP. GAS SERVICE LINE. REFER TO MEP FOR SIZE.	
G	APPROX. LOCATION OF PROP. GAS METER. REFER TO MEP PLANS FOR CONTINUATION.	
H	PROP. GAS ENTRY. REFERENCE PLUMBING PLANS FOR CONTINUATION.	
	PROP. 6" SDR-35 SANITARY SEWER PIPE	
J	PROP. 4" CAST IRON PIPE FOR FIRST 10' FROM BUILDING	
K	PROP. 6" CAST IRON PIPE FOR FIRST 10' FROM BUILDING	
L	PROP. THRUST BLOCK. REFER TO SHEET C-903 FOR DETAIL.	
M	APPROX. LOCATION OF EXISTING 6" WATER SERVICE. FINAL LOCATION TO BE CONFIRMED PRIOR TO CONSTRUCTION. GC TO COORDINATE WITH UTILITY PROVIDER.	
0	TWO (2) PROP. 1" COPPER DOMESTIC WATER LINES (HOT & COLD) CONNECTING TO TRASH ENCLOSURE	IL
P	PROP. 6" DIA. CLDI WATER SERVICE.	lΓ
Q	PROP. 2" DIA. TYPE K COPPER WATER SERVICE	
R	PROP. 6" WATER ENTRY WITH CURB STOP. REFERENCE MEP PLANS FOR CONTINUATION.	
S	PROP. 2" DOMESTIC WATER ENTRY WITH CURB STOP. REFERENCE MEP PLANS FOR CONTINUATION.	
T	PROP. WATER SHUT-OFF VALVE	
U	PROP. FIRE DEPARTMENT WATER SERVICE CONNECTION. REFERENCE MEP PLANS FOR CONTINUATION.	
V	APPROX. LOCATION OF 3" VENT LINE TO GREASE TRAP. REFERENCE MEP PLANS FOR CONTINUATION.	
W	PROP. CONCRETE ENCASEMENT. REFER TO SHEET C-903 FOR DETAIL.	
X	APPROX. LOCATION OF EXISTING GAS SERVICE. FINAL LOCATION TO BE CONFIRMED PRIOR TO CONSTRUCTION. GC TO COORDINATE WITH UTILITY PROVIDER.	

Y PROP. AREA DRAIN. REFERENCE ARCHITECTURAL / MEP PLANS.

PROP. ELECTRIC SERVICE FOR EV CHARGING STATIONS.

PROP. FUTURE ELECTRIC SERVICE FOR EV CHARGING STATIONS.

THIS PLAN TO BE UTILIZED FOR UTILITIES PURPOSES ONLY

SCALE: 1" = 20'

REFERENCE MEP PLANS FOR CONTINUATION.

REFERENCE MEP PLANS FOR CONTINUATION.



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SITE DEVELOPMENT

**PLANS** 

PROPOSED

DEVELOPMENT

MAP: 39 | BLK: 29 | LOT: 1C **494 LINCOLN STREET WORCESTER COUNTY WORCESTER, MASSACHUSETTS** 

STORE:

PROTOTYPE 6-V-AV **RESTAURANT #RC1233** 

**DESIGNER INFORMATION:** 

352 TURNPIKE ROAD, 3rd FLOOR SOUTHBOROUGH, MA 01772 Phone: (508) 480-9900


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SHEET TITLE:

**UTILITY** & DRAINAGE PLAN

C-501



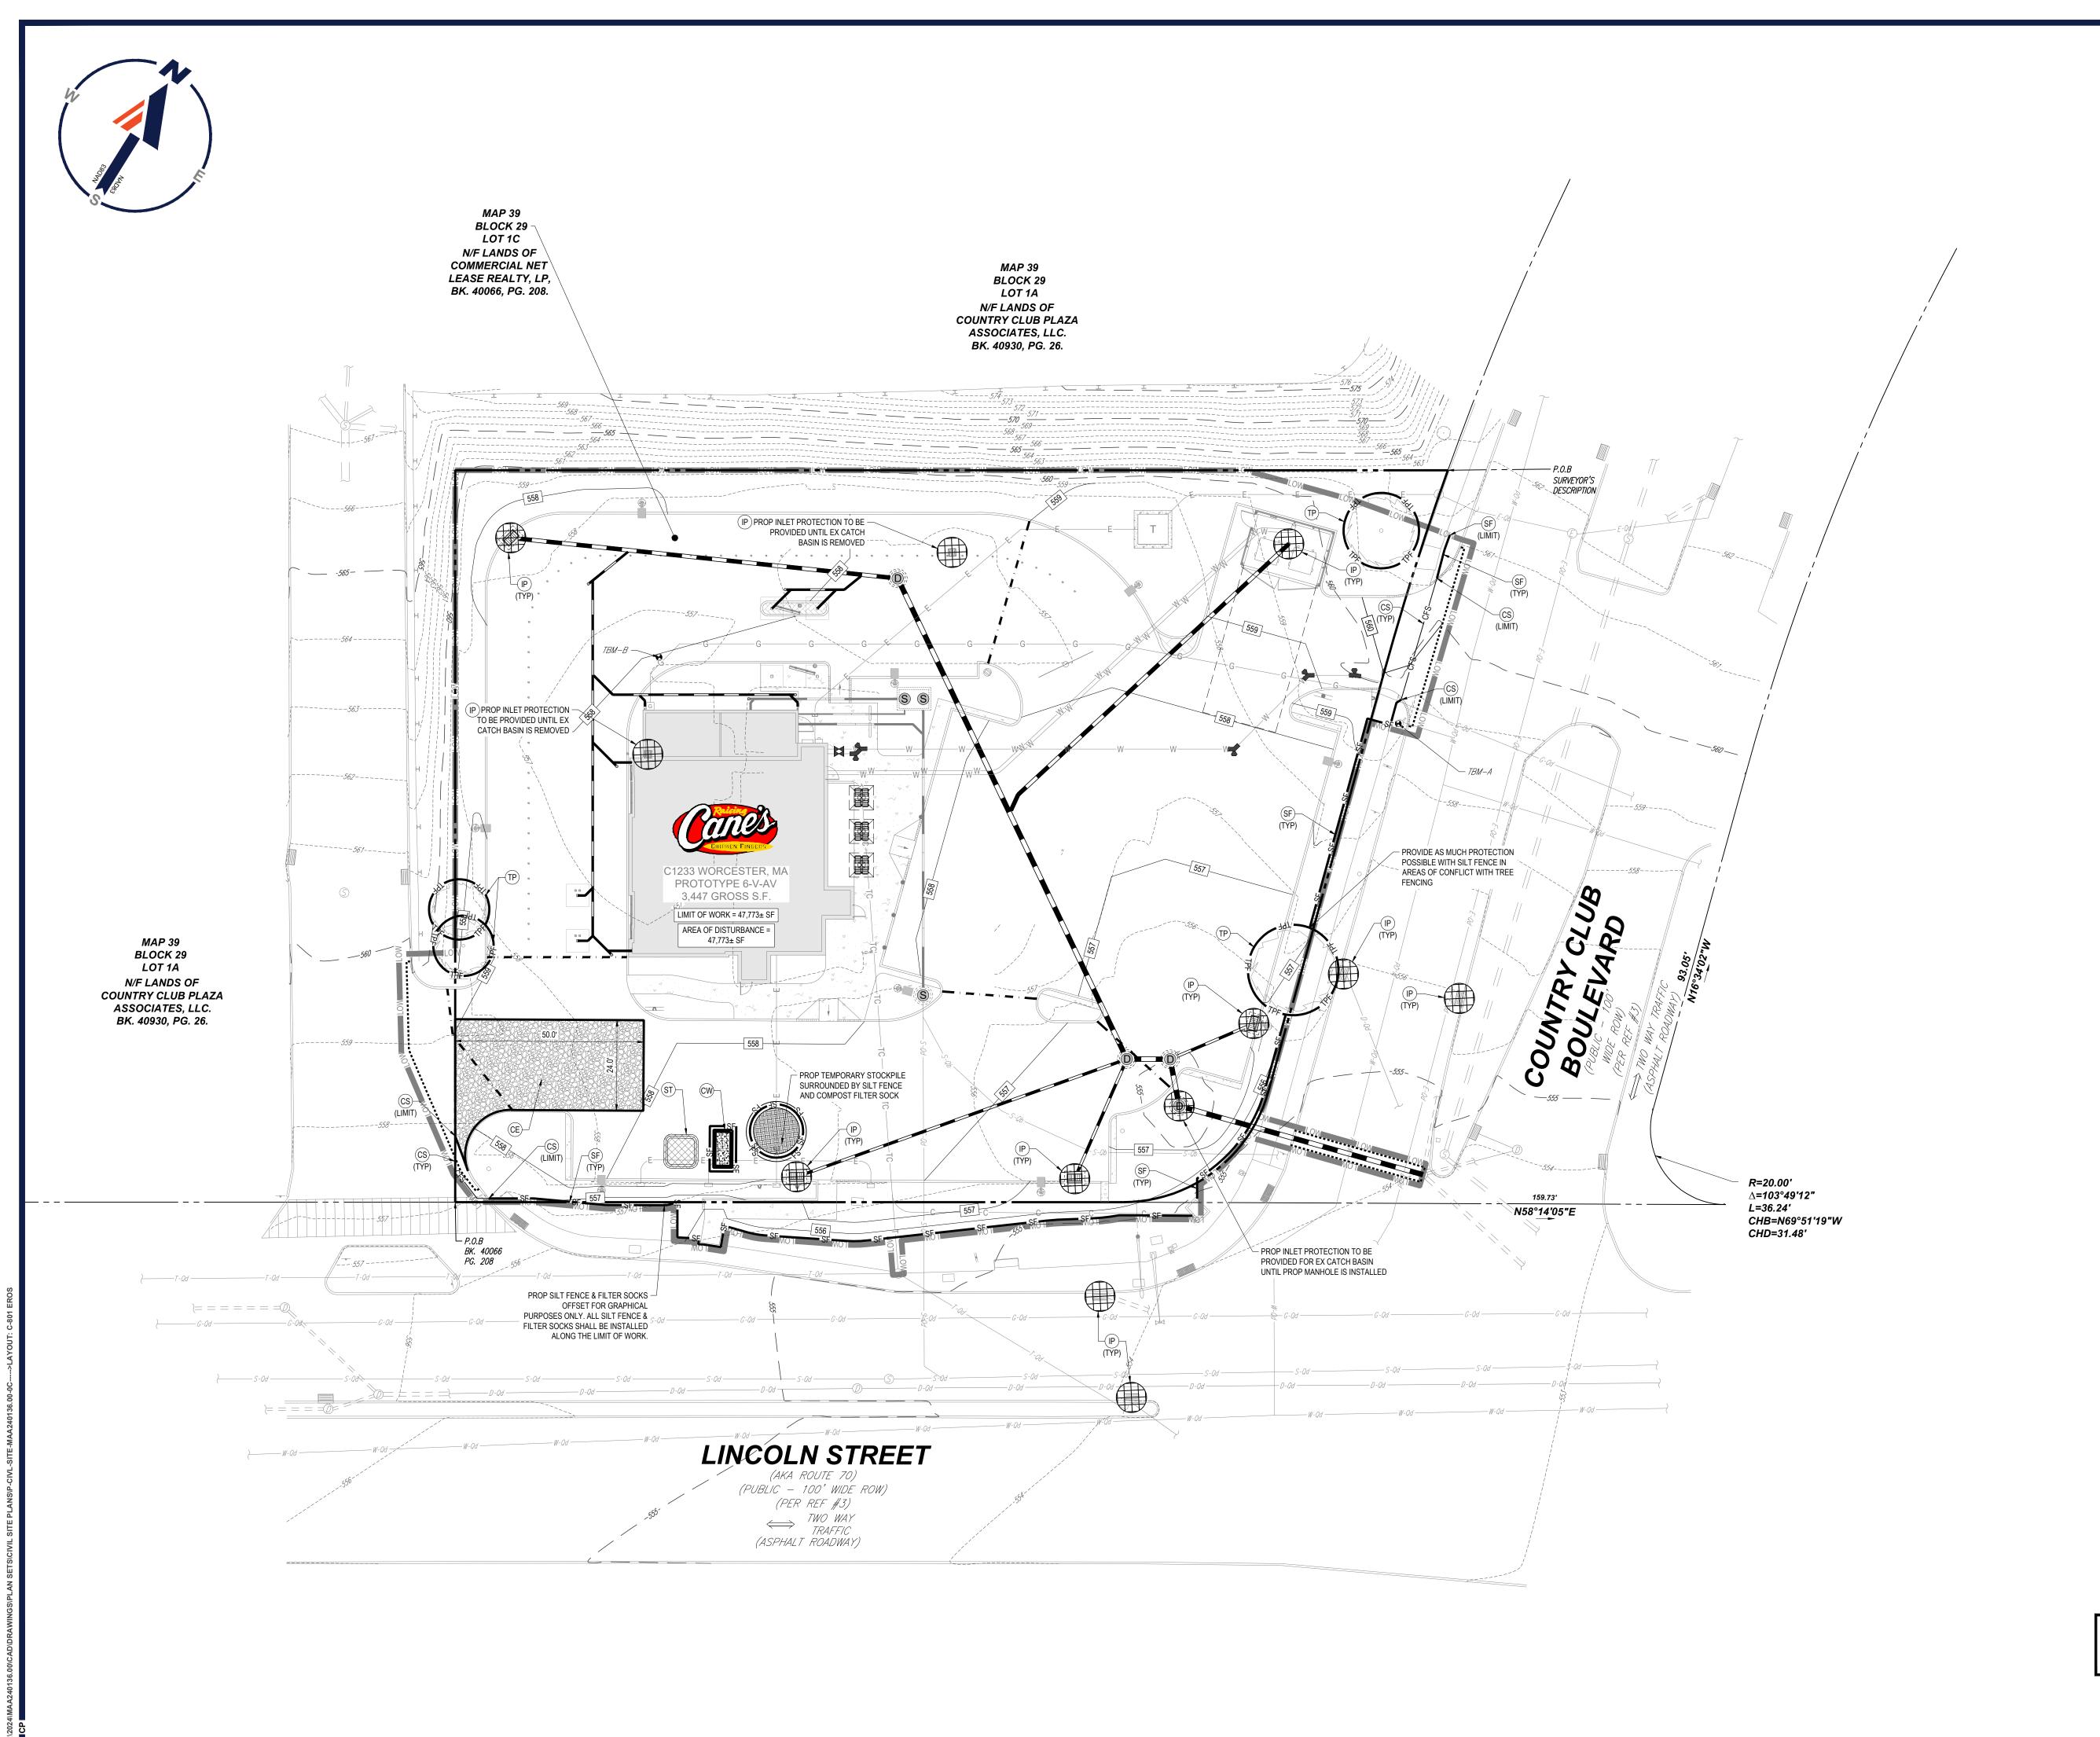

PROPERTY LINE

----- EXISTING CONTOUR LOW APPROXIMATE LIMIT OF DISTURBANCE SF——(SF) SILT FENCE

CFS———(CS) COMPOST FILTER SOCK

(CE) CONSTRUCTION ENTRANCE PROPOSED GRATE INLET PROTECTION.



SEE DETAIL SHEET. (TP) TREE PROTECTION



(CW) CONCRETE WASHOUT

ST) MATERIALS AND WASTE STORAGE AREA.



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PROTOTYPE 6-V-AV RESTAURANT #RC1233

**DESIGNER INFORMATION:** 

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SOUTHBOROUGH, MA 01772 Phone: (508) 480-9900 www.BohlerEngineering.com




**SOIL EROSION AND SEDIMENT CONTROL PLAN** 


THIS PLAN TO BE UTILIZED FOR SOIL EROSION AND SEDIMENT
SHEET NUMBER:

CONTROL PURPOSES ONLY

C-801

### MASSACHUSETTS EROSION AND SEDIMENT CONTROL NOTES GENERAL EROSION AND SEDIMENT CONTROL NOTES BINDING WIRE - EXISTING GROUND 2 PER BALE) PLYWOOD 48" X -SEE CHART 1 ROWLENGTH OF STONE REQUIRED - 10 MIL PLASTIC STRAW RALE ALL SEDIMENT AND EROSION CONTROL MEASURES SHALL BE DONE AS SET FORTH IN THE MOST CURRENT STATE SEDIMENT AND THE GENERAL NOTES MUST BE INCLUDED AS PART OF THIS ENTIRE DOCUMENT PACKAGE AND ARE PART OF THE CONTRACT DOCUMENTS. THE GENERA WHITE (SEE NOTE 6) NOTES ARE REFERENCED HEREIN. AND THE CONTRACTOR MUST REFER TO THEM AND FULLY COMPLY WITH THESE NOTES. IN THEIR ENTIRETY, THE 0 TO 2% CONTRACTOR MUST BE FAMILIAR WITH AND ACKNOWLEDGE FAMILIARITY WITH ALL OF THE GENERAL NOTES AND ALL OF THE PLANS' SPECIFIC NOTES **SECTION A-A** WOOD OR METAL CONCRETE THOSE AREAS UNDERGOING ACTUAL CONSTRUCTION WILL BE LEFT IN AN UNTREATED OR UNVEGETATED CONDITION FOR A MINIMUM 2% TO 5% STAKES (2 PER BALE) WASHOU FROSION CONTROL MEASURES MUST CONFORM TO THE STATE LOCAL AND FEDERAL GUIDELINES FOR URBAN FROSION AND SEDIMENT CONTROL TIME. AREAS SHALL BE PERMANENTLY STABILIZED IN ACCORDANCE WITH LOCAL, STATE, AND FEDERAL REQUIREMENTS. AT A ENTIRE ENTRANCE STABILIZED WITH FABC BASE COURSE ( - NATIVE MATERIAI UNIESS OTHERWISE NOTED, OR UNIESS THE PROFESSIONAL OF RECORD CLEARLY AND SPECIFICALLY, IN WRITING, DIRECTS OTHERWISE, INSTALLATION MINIMUM AREAS SHALL BE PERMANENTLY STABILIZED ACCORDING TO THE CURRENT EDITION OF THE STORMWATER POLILITION OF EROSION CONTROL, CLEARING, AND SITE WORK MUST BE PERFORMED EXACTLY AS INDICATED IN THE EROSION CONTROL CONSTRUCTION NOTES (1) AS PRESCRIBED BY LOCAL ORDINANCE OR OTHER GOVERNING AUTHORITY. PREVENTION PLAN (SWPPP) OR IN THE ABSENCE OF A SWPPP, THEY SHALL BE PERMANENTLY STABILIZED WITHIN 14 DAYS OF FINAL BLACK -- 0.5" LAG SCREWS GRADING AND TEMPORARILY STABILIZED WITHIN 30 DAYS OF INITIAL DISTURBANCE OF THE SOIL. IF THE DISTURBANCE IS WITHIN 100 CHART 1 STEEL WIRE . THE DISTURBED LAND AREA OF THIS SITE IS APPROXIMATELY XXX.XX ACRES FEET OF A STREAM OR POND, THE AREA SHALL BE STABILIZED WITHIN 7 DAYS OR PRIOR TO ANY STORM EVENT (THIS WOULD PROVIDE APPROPRIATE TRANSITION 2-1/2" CLEAN STONE -4. THE FOLLOWING EROSION CONTROL MEASURES ARE PROPOSED FOR THIS SITE BETWEEN STABILIZED CONSTRUCTION STAPLE DETAIL a) STABILIZED CONSTRUCTION ENTRANCE/EXIT - A TEMPORARY GRAVEL CONSTRUCTION ENTRANCE/EXIT IS TO BE INSTALLED AT THE DESIGNATED ENTRANCE AND PUBLIC R.O.W. - WOOD **PROFILE** SEDIMENT BARRIERS (SILT FENCE, STRAW BARRIERS, ETC.) SHOULD BE INSTALLED PRIOR TO ANY SOIL DISTURBANCE OF THE LOCATION SHOWN ON THE PLAN. THIS AREA MUST BE GRADED SO THAT RUNOFF WATER WILL BE RETAINED ON-SITE. TEMPORARY CONCRETE WASHOUT FACILITIES CONTRIBUTING DRAINAGE AREA ABOVE THEM. MULCH NETTING SHALL BE USED TO ANCHOR MULCH IN ALL AREAS WITH SLOPES b) SEDIMENT FENCE - INSTALL SILT FENCE(S) AND/OR SILT SOCK AROUND ALL OF THE DOWNSLOPE PERIMETERS OF THE SITE, TEMPORARY FILL AND SOIL SHOULD BE LOCATED A MINIMUM OF 50 FT FROM STORM DRAIN INLETS. c) INSTALL FILTER FABRIC DROP INLET PROTECTION AROUND EACH DRAINAGE INLET AS DRAINAGE STRUCTURES ARE INSTALLED TO REDUCE THE ONCE CONCRETE WASTES ARE WASHED INTO **CONCRETE WASHOUT SIGN** INSTALL SILTATION BARRIER AT TOE OF SLOPE TO FILTER SILT FROM RUNOFF. SEE SILTATION BARRIER DETAILS FOR PROPER QUANTITY OF SEDIMENT. INSTALL TEMPORARY INLET PROTECTION ON INLETS DOWNSLOPE FROM DISTURBANCE, WHICH MAY BE BEYOND THE LIMITS THE DESIGNATED AREA AND ALLOWED TO **DETAIL (OR EQUIVALENT)** INSTALLATION. SILTATION BARRIER WILL REMAIN IN PLACE PER NOTE #5. HARDEN. THE CONCRETE SHOULD BE BROKEN ALL EROSION CONTROL STRUCTURES WILL BE INSPECTED. REPLACED AND/OR REPAIRED EVERY 7 DAYS AND IMMEDIATELY UP\_REMOVED\_AND DISPOSED OF OFF-SITE INSTALLATION OF EROSION CONTROL DEVICES MUST BE IN ACCORDANCE WITH ALL OF THE MANUFACTURER'S RECOMMENDATIONS CONTRACTOR TO DISPOSE OF HARDENED FOLLOWING ANY SIGNIFICANT RAINFALL OR SNOW MELT OR WHEN NO LONGER SERVICEABLE DUE TO SEDIMENT ACCUMULATION OR CONCRETE ON A REGULAR BASIS. THE CONTRACTOR MUST INSPECT FROSION CONTROL MEASURES WEEKLY. THE CONTRACTOR MUST REMOVE ANY SILT DEPOSITS GREATER THAN 6 DECOMPOSITION SEDIMENT DEPOSITS SHOULD BE REMOVED AFTER EACH STORM EVENT. THEY MUST BE REMOVED WHEN THE CONCRETE WASHOUT SIGN SHALL BE DEPOSITS REACH APPROXIMATELY ONE HALF THE HEIGHT OF THE BARRIER. SEDIMENT CONTROL DEVICES SHALL REMAIN IN PLACE INCHES OR HALF THE EROSION CONTROL BARRIER'S HEIGHT COLLECTED ON THE FILTER FABRIC AND/OR SILT SOCK BARRIERS AND EXCAVATE AND - PUBLIC INSTALLED WITHIN 30 FT. OF THE TEMPORARY 10' STAKE (TYP) -AND BE MAINTAINED BY THE CONTRACTOR UNTIL AREAS UPSLOPE ARE PERMANENTLY STABILIZED. FOR SEDIMENT CONTROL RIGHT OF CONCRETE WASHOUT FACILITY. DEVICES THAT ARE WITHIN AREAS SUBJECT TO CONSERVATION COMMISSION JURISDICTION, THE DEVICES SHALL REMAIN IN PLACE PLASTIC LINING MATERIAL SHOULD BE A THE CONTRACTOR MUST APPLY TEMPORARY SEED AND MUICH TO ALL DISTURRED AREAS THAT WILL NOT RE RROUGHT TO FINISHED GRADE AND GROUND AND BE REMOVED IN ACCORDANCE WITH THE ORDER OF CONDITIONS. VEGETATED WITHIN 7 DAYS. WHEN AREAS ARE DISTURBED AFTER THE GROWING SEASON. THE CONTRACTOR MUST STABILIZE SAME WITH GEOTEXTILE FABRIC AND MAINTAIN SAME IN STRICT ACCORDANCE WITH BEST MANAGEMENT PRACTICES. NO SLOPES, EITHER PERMANENT OR TEMPORARY, SHALL BE STEEPER THAN TWO TO ONE (2:1) UNLESS OTHERWISE INDICATED ON THE PLANS. SLOPE PROTECTION FOR SLOPES GREATER THAN 2:1 SHALL BE DESIGNED BY A GEOTECHNICAL ENGINEER. IMPERMEABILITY OF THE MATERIAL 8. THE CONTRACTOR MUST INSTALL ADDITIONAL EROSION CONTROL MEASURES IF THE PROFESSIONAL OF RECORD SO REQUIRES, TO PREVENT ANY, WASHOUT FACILITIES MUST BE CLEANED, OR INCLUDING THE INCIDENTAL, DISCHARGE OF SILT-LADEN RUNOFF FROM EXITING THE SITE. IF FINAL SEEDING OF THE DISTURBED AREAS IS NOT COMPLETED 45 DAYS PRIOR TO THE FIRST KILLING FROST, USE TEMPORARY NEW FACILITIES MUST BE CONSTRUCTED AND Restaurant Support Office STRAW BALE (TYP) MULCH (DORMANT SEEDING MAY BE ATTEMPTED AS WELL) TO PROTECT THE SITE AND DELAY SEEDING UNTIL THE NEXT 9. THE CONTRACTOR MUST BE RESPONSIBLE FOR INSPECTING AND MAINTAINING ALL EROSION CONTROL MEASURES ON THE SITE UNTIL PERMANENT READY FOR USE ONCE THE WASHOUT IS 75% 6800 Bishop Road, Plano, TX 75024 PAVING AND TURE/LANDSCAPING IS ESTABLISHED. THE COSTS OF INSTALLING AND MAINTAINING THE FROSION CONTROL MEASURES MUST BE PLAN VIEW STRAW BALE AND STAPLES MAY BE Tele: 972-769-3100 Fax: 972-769-310 INCLUDED IN THE BID PRICE FOR THE SITE WORK AND THE CONTRACTOR IS RESPONSIBLE FOR ALL SUCH COSTS. TEMPORARY SEEDING OF DISTURBED AREAS THAT HAVE NOT BEEN FINAL GRADED SHALL BE COMPLETED 45 DAYS PRIOR TO THE SUBSTITUTED WITH ALTERNATE SECURING 10. THE CONTRACTOR MUST CONTINUE TO MAINTAIN ALL FROSION CONTROL MEASURES UNTIL THE COMPLETION OF CONSTRUCTION AND THE FIRST KILLING FROST TO PROTECT FROM SPRING RUNOFF PROBLEMS. MEASURES SUCH AS CONCRETE BLOCK. PLAN PROTOTYPE ISSUE DATE: ESTABLISHMENT OF VEGETATION. DURING THE CONSTRUCTION PHASE, INTERCEPTED SEDIMENT SHALL BE REMOVED AND DISPOSED OF IN ACCORDANCE WITH LOCAL, 11. THE CONTRACTOR MUST REMOVE EROSION CONTROL MEASURES, SILT AND DEBRIS AFTER ESTABLISHING PERMANENT VEGETATION COVER OR OTHER **CONCRETE WASTE REVISIONS** INSTALLING A DIFFERENT. SPECIFIED METHOD OF STABILIZATION REVEGETATION MEASURES WILL COMMENCE UPON COMPLETION OF CONSTRUCTION EXCEPT AS NOTED ABOVE. ALL DISTURBED STABILIZED CONSTRUCTION ENTRANCE 12. THIS PLAN REPRESENTS THE MINIMUM LEVEL OF IMPLEMENTATION OF TEMPORARY EROSION AND SEDIMENTATION CONTROL FACILITIES. MEASURES AREAS NOT OTHERWISE STABILIZED WILL BE GRADED, SMOOTHED, AND PREPARED FOR FINAL SEEDING AS FOLLOWS: AND STRUCTURES. ADDITIONAL FACILITIES, MEASURES AND STRUCTURES MUST BE INSTALLED WHERE NECESSARY TO COMPLY WITH ALL APPLICABLE COMMENT REV DATE ) SIX INCHES, OR DEPTH SPECIFIED ON THE LANDSCAPE PLAN, OF LOAM WILL BE SPREAD OVER DISTURBED AREAS AND SMOOTHED CODES AND STANDARDS AND/OR TO PREVENT ANY INCLUDING THE INCIDENTAL DISCHARGE OF SILT-LADEN RUNOFF FROM EXITING THE SITE TO A UNIFORM SURFACE REVISED PER CITY 10/22/2024 COMMENTS 13. THE CONTRACTOR MUST PROTECT ALL EXISTING TREES AND SHRUBS. THE CONTRACTOR MUST REFER TO THE LANDSCAPE AND/OR DEMOLITION PLANS APPLY LIMESTONE AND FERTILIZER ACCORDING TO SOIL TEST. IF SOIL TESTING IS NOT FEASIBLE ON SMALL OR VARIABLE SITES, OR AREA OF SITE CONSTRUCTION 2 RE-BARS STEEL PICKETS OR 2"x -FOR TREE PROTECTION, FENCE LOCATIONS AND DETAILS WHERE TIMING IS CRITICAL. FERTILIZER MAY BE APPLIED AT THE RATE OF 800 LB PER ACRE OR 18.4 LB PER 1.000 SF USING 10-20-20 WOOD OR PLASTIC SLAT STAPLED-2" STAKE 1 1/2' TO 2' IN GROUND OR EQUIVALENT, APPLY GROUND LIMESTONE (EQUIVALENT TO 50% CALCIUM PLUS MAGNESIUM OXIDE) AT A RATE OF 3 TONS PER 14. THE CONTRACTOR MUST REFER TO GRADING PLANS FOR ADDITIONAL INFORMATION DRIVE STAKES FLUSH WITH BALES ACRE (138 LB PER 1.000 SF) 15 THE CONTRACTOR MUIST CLEAN EXISTING AND PROPOSED DRAINAGE STRUCTURES AND INTERCONNECTING PIPES ON OR OFE-SITE AS THE FOLLOWING SEED BED PREPARATION, DITCHES AND BACK SLOPES WILL BE SEEDED TO A MIXTURE OF 47% CREEPING RED FESCUE. **DETAIL OF POST ATTACHMENT** ANGLE FIRST STAKE TOWARDS JURISDICTIONAL AGENCY REQUIRES. BOTH AT THE TIME OF SITE STABILIZATION AND AT END OF PROJECT AREA WITHIN PROTECTION ZONE/TREE 5% REDTOP, AND 48% TALL FESCUE, THE LAWN AREAS WILL BE SEEDED TO A PREMIUM TURE MIXTURE OF 44% KENTLICKY PREVIOUSLY LAID BALE DRIP LINE FENCE TO FOLLOW TREE DRO 16. SOIL FROSION CONTROL MEASURES MUST BE ADJUSTED OR RELOCATED BY THE CONTRACTOR AS IDENTIFIED DURING SITE OBSERVATION IN ORDER TO BLUE-GRASS, 44% CREEPING RED FESCUE, AND 12% PERENNIAL RYEGRASS: SEEDING RATE IS 1.03 LBS PER 1,000 SF LAWN. LINE OR 6' FROM TRUNK, WHICHEVER IS MAINTAIN THE COMPLETE FEFECTIVENESS OF ALL CONTROL MEASURES QUALITY SOD MAY BE SUBSTITUTED FOR SEED WHERE SLOPES DO NOT EXCEED 2:1. SOD ON SLOPES STEEPER THAN 3:1 SHOULD -SILT FENCE (3' WID 17. THE CONTRACTOR MUST IDENTIFY, ON THE PLAN, THE LOCATION OF WASTE CONTAINERS, FUEL STORAGE TANKS, CONCRETE WASHOUT AREAS AND AN STRAW MULCH AT THE RATE OF 70-90 LBS PER 1.000 SF. A HYDRO-APPLICATION OF WOOD OR PAPER FIBER SHALL BE APPLIED OTHER LOCATIONS WHERE HAZARDOUS MATERIALS ARE STORED. FOLLOWING SEEDING, A SUITABLE NON-TOXIC BINDER WILL BE USED ON STRAW MULCH FOR WIND CONTROL. 4' WOOD & WIRE SNOW BOUND BALES PLACED -ALL TEMPORARY EROSION CONTROL MEASURES SHALL BE REMOVED ONCE THE SITE IS 70% STABILIZED. FOR EROSION CONTROL THE FOLLOWING CONSTRUCTION SEQUENCE IS RECOMMENDED FENCE WITH STEEL STAKE 18" ON CONTOUR MEASURES THAT ARE WITHIN AREAS SUBJECT TO CONSERVATION COMMISSION JURISDICTION, THE MEASURES SHALL REMAIN IN PLACE AND BE REMOVED IN ACCORDANCE WITH THE ORDER OF CONDITIONS. INSTALLATION OF STABILIZED CONSTRUCTION ENTRANCE/EXIT (AS SHOWN) INSTALLATION OF EROSION CONTROL BARRIER (STRAW BALES AND SILT FENCE) (AS SHOWN) 2" MAX WETLANDS WILL BE PROTECTED WITH BARRIERS CONSISTING OF STRAW BALES, COMPOST TUBES, SILT FENCE OR A COMBINATION ROCKY INSTALLATION OF INLET PROTECTION IN STREET (AS SHOWN SOIL.) • DEMOLITION OF EXISTING SITE STRUCTURES (SEE DEMOLITION PLAN) DEMOLITION OF EXISTING SITE PAVEMENT AND AMENITIES (SEE DEMOLITION PLAN) 13. $\,$ ALL AREAS WITHIN 100 FEET OF A FLAGGED WETLAND OR STREAM SHALL HAVE AN EXPOSURE WINDOW OF NOT MORE THAN 7 DAYS. WOOD & WIRE SNOW FENCE USED AS CLEARING AND GRUBBING TREE GUARD TO PREVENT DAMAGE FROM NATIVE SOIL 14. ALL AREAS WITHIN 100 FEET OF A FLAGGED WETLAND OR STREAM SHALL FOLLOW APPROPRIATE EROSION CONTROL MEASURES CONSTRUCTION EQUIPMENT INSTALLATION OF TEMPORARY SWALES AND SEDIMENT BASINS PRIOR TO EACH STORM IF NOT BEING ACTIVELY WORKED: -BACKFILL EARTHWORK AND EXCAVATION/FILLING AS NECESSARY CONSTRUCTION OF UTILITIES TOE-IN METHODS TREE DRIP LINE/TREE PROTECTION ZONE PERSPECTIVE OF FENCE STABILIZE PERMANENT LAWN AREAS AND SLOPES WITH TEMPORARY SEEDING LOCATION MULCH RATE (1000 SF BALES SHALL BE PLACED AT THE TOP OF A SLOPE OR ON THE CONTOUR AND IN A ROW WITH INSTALLATION OF INLET PROTECTION OF ON-SITE UTILITIES (AS SHOWN) STRAW 100 POUNDS PROTECTED AREA ENDS TIGHTLY ABUTTING THE ADJACENT BALES. CONSTRUCTION OF BUILDINGS AREA WITHIN TREE PROTECTION ZONE T EACH BALE SHALL BE PLACED SO THE BINDINGS ARE HORIZONTAL CONSTRUCTION OF ALL CURBING AND LANDSCAPE ISLANDS AS INDICATED ON THE PLANS WINDY AREA SHREDDED OR CHOPPED CORNSTALKS 185-275 POUNDS REMAIN UNDISTURBED DURING BALES SHALL BE SECURELY ANCHORED IN PLACE BY EITHER TWO STAKES OR RE-BARS DRIVEN SPREAD TOPSOIL ON SLOPED AREAS AND SEED AND MULCH **Call** before you dig EXCAVATE A 6"x6" TRENCH ALONG THE LINE OF EROSION CONTROL OF THE SITE. CONSTRUCTION THROUGH THE BALE. THE FIRST STAKE IN EACH BALE SHALL BE DRIVEN TOWARD THE STRAW (ANCHORED)\* 100 POUNDS FINAL GRADING OF ALL SLOPED AREAS UNROLL SILTATION FENCE AND POSITION THE POSTS AGAINST THE BACK (DOWNSTREAM) PREVIOUSLY LAID BALE AT AN ANGLE TO FORCE THE BALES TOGETHER. STAKES SHALL BE **ALWAYS CALL 811** PLACE 6" TOPSOIL ON SLOPES AFTER FINAL GRADING COMPLETED. FERTILIZE, SEED, AND MULCH SEED MIXTURE TO BE INSTALLED WALL OF THE TRENCH (NET SIDE AWAY FROM FLOW DIRECTION) DRIVEN FLUSH WITH THE BALE. 4' WOOD & WIRE SNOW FENCE DRIVE THE POST INTO THE GROUND UNTIL THE NETTING IS LAYING ACROSS THE TRENCH MODERATE TO HIGH JUTE MESH OR EXCELSIOR MAT AS REQUIRED AS REQUIRED INSPECTION SHALL BE FREQUENT AND REPAIR REPLACEMENT SHALL BE PROMPTLY AS NEEDED WITH STEEL STAKES 18' O.C It's fast. It's free. It's the law. BOTTOM REMOVAL OF THE TEMPORARY SEDIMENT BASINS DRAINAGE AREA NO MORE THAN \$\frac{1}{4}\$ AC. PER 100 FEEL OF STRAW BALE DIKE FOR SLOPES LESS VELOCITY AREAS OR LAY THE TOE-IN FLAP OF THE FABRIC ONTO THE UNDISTURBED BOTTOM OF THE TRENCH, PAVE PARKING LOT STEEP SLOPES GREATER BACKFILL ALSO BE ACCOMPLISHED BY LAYING FABRIC FLAP ON UNDISTURBED GROUND AND BALES SHALL BE REMOVED WHEN THEY HAVE SERVED THEIR USEFULNESS SO AS NOT TO BLOCK LANDSCAPING PER LANDSCAPING PLAN PILING & TAMPING FILL AT THE BASE. OR IMPEDE STORM FLOW OR DRAINAGE. • REMOVE EROSION CONTROLS AS DISTURBED AREAS BECOME STABILIZED TO 70% STABILIZATION OR GREATER **ENTITLEMENT SET** (REFER TO GEOTECHNICAL REPORT FOR FINAL DESIGN REQUIREMENT) GREATER THAN 3:1 TREE PROTECTION DURING \* A HYDRO-APPLICATION OF WOOD OR PAPER FIBER MAY BE APPLIED FOLLOWING SEEDING. A SUITABLE NON-TOXIC BINDER SHALL STRAW BALE BARRIER SILT FENCE BE USED TO ADDITIONAL WIND CONTROL. SITE CONSTRUCTION THIS DRAWING IS INTENDED FOR MUNICIPAL AND/OR AGENC EVIEW AND APPROVAL. IT IS NOT INTENDED AS A CONSTRUC \* MULCH ANCHORING: ANCHOR MULCH WITH PEG AND TWINE (1 SQ. YD/BLOCK); MULCH NETTING (AS PER MANUFACTURER); WOOD DOCUMENT UNLESS INDICATED OTHERWISE E-O030201 - 09/2023) NE-O030302 - 09/2023) CELLULOSE FIBER (750 LBS/ACRE): CHEMICAL TACK (AS PER MANUFACTURER'S SPECIFICATIONS): USE OF A SERRATED STRAIGHT - COMPOST FILTER SOCK (SEE PLAN FOR SIZE PROJECT No.: DISK. WETTING FOR SMALL AREAS AND ROAD DITCHES MAY BE PERMITTED PAVEMENT OR DRAWN BY: IMPERVIOUS SURFACE PROPOSED LOCATIONS OF SURFACE STORMWATER MANAGEMENT BASINS CAN BE UTILIZED AS A TEMPORARY SEDIMENT TRAP - CONCRETE BLOCKS OR SAND FEDERAL REQUIREMENTS. CAD I.D. X-CIVL-TTLE TEMPORARY SEDIMENT TRAPS SHALL BE SIZED PER THE CURRENT EDITION OF THE "MASSACHUSETTS EROSION AND SEDIMENT PROTECTED CONTROL GUIDELINES FOR URBAN AND SUBURBAN AREAS" AND PROVIDE A MINIMUM OF 1,800 CF PER ACRE OF TRIBUTARY AREA PROJECT: WITH A MAXIMUM TRIBUTARY AREA OF 5 ACRES, MAINTAIN A 2:1 LENGTH TO WIDTH RATIO, AND NOT EXCEED 5 FT IN HEIGHT. UPON SITE STABILIZATION, ACCUMULATED SEDIMENT SHALL BE REMOVED AND THE TEMPORARY SEDIMENT TRAP EXCAVATED TO 1 FOOT SITE DEVELOPMENT BELOW THE TRAP. THE AREA SHALL THEN BE SCARIFIED TO PREVENT COMPACTION AND PROMOTE INFILTRATION, AND GRADED - 2" X 2" X 36" WOODEN STAKES PLACED 10' O.C. PREPARE SOIL BEFORE INSTALLING BLANKETS, INCLUDING ANY NECESSARY APPLICATION OF LIM AND STABILIZED IN ACCORDANCE WITH THE GRADING AND LANDSCAPE PLANS. FERTILIZER, AND SEED **PLANS** BLOWN/PLACED - COMPOSITE FILTER SOCK (SEE PLAN FOR SIZE) STOCKPILING OF MATERIALS (DIRT, WOOD, CONSTRUCTION MATERIALS, ETC.) MUST REMAIN COVERED AT ALL TIMES TO MINIMIZE 2. BEGIN AT THE TOP OF THE SLOPE BY ANCHORING THE BLANKET IN A 6" DEEP X 6" WIDE TRENCH FILTER MEDIA ANY DUST PROBLEMS THAT MAY OCCUR WITH ADJACENT PROPERTIES AND TO PROVIDE MAXIMUM PROTECTION AGAINST EROSION WITH APPROXIMATELY 12" OF BLANKET EXTENDED BEYOND THE UP-SLOPE PORTION OF THE AREA TO BE PROTECTED TRENCH AS SHOWN IN DETAIL 2. ANCHOR THE BLANKET WITH A ROW OF STAPLES/STAKES CONCRETE BLOCKS OR SAND APPROXIMATELY 12" APART IN THE BOTTOM OF THE TRENCH. BACKFILL AND COMPACT THE TRENCI WORK AREA 7. EXISTING CATCH BASIN STRUCTURES SHALL BE PROTECTED UNTIL SUCH TIME AS THEY ARE REMOVED. BAGS SIZED AS NEEDED (10' O.C.) AFTER STAPLING APPLY SEED TO COMPACTED SOIL AND FOLD REMAINING 12" PORTION OF BLANKET BACK OVER SEED AND COMPACTED SOIL. SECURE BLANKET OVER COMPACTED SOIL WITH THE CONTRACTOR MUST PERFORM DEWATERING (IF REQUIRED), IN ACCORDANCE WITH STATE AND LOCAL REGULATIONS, IT IS THE A ROW OF STAPLES/STAKES SPACED APPROXIMATELY 12" APART ACROSS THE WIDTH OF THE PROPOSED CONTRACTOR'S RESPONSIBILITY TO OBTAIN AND PAY FOR THE COSTS ASSOCIATED WITH ANY AND ALL NECESSARY DISCHARGE **DEVELOPMENT** 3. ROLL THE BLANKETS (A.) DOWN OR (B.) HORIZONTALLY ACROSS THE SLOPE. BLANKETS WILL AREA TO BE UNROLL WITH APPROPRIATE SIDE AGAINST THE SOIL SURFACE. ALL BLANKETS MUST BE SECURELY THE CONTRACTOR MUST LOCATE CONSTRUCTION WASTE MATERIAL STORAGE AREAS TO MINIMIZE EXPOSURE TO STORMWATER. **PROTECTED** FASTENED TO SOIL SURFACE BY PLACING STAPLES/STAKES IN APPROPRIATE LOCATIONS AS PER MAP: 39 | BLK: 29 | LOT: 1C THE CONTRACTOR MUST IMMEDIATELY PLACE CONSTRUCTION WASTE IN ON-SITE STORAGE CONTAINERS UNTIL THAT MANUFACTURES RECOMMENDATION CONSTRUCTION WASTE IS READY FOR OFE-SITE DISPOSAL. THE CONTRACTOR MUST MAINTAIN SPILL PREVENTION AND RESPONSE 4. THE EDGES OF PARALLEL BLANKETS MUST BE STAPLED WITH MINIMUM 6" OVERLAP. TO ENSURE **494 LINCOLN STREET** COMPOST FILTER SOCK WATER FLOW SECTION PROPER SEAM ALIGNMENT, PLACE THE EDGE OF THE OVERLAPPING BLANKET (BLANKET BEING EQUIPMENT AND MAKE SAME CONTINUOUSLY AVAILABLE ON-SITE FOR USE BY THE CONTRACTOR'S EMPLOYEES WHO MUST BE (SEE PLAN FOR SIZE) **WORCESTER COUNTY** INSTALLED ON TOP) EVEN WITH THE SEAM STITCH ON THE PREVIOUSLY INSTALLED BLANKET. PROPERLY TRAINED IN THE APPLICATION OF SPILL PREVENTION AND RESPONSE PROCEDURES. WORCESTER, MASSACHUSETTS CONSECUTIVE BLANKETS SPLICED DOWN THE SLOPE MUST BE PLACED END OVER END (SHINGLE STYLE) WITH AN APPROXIMATE 3" OVERLAP. STAPLE THROUGH OVERLAPPED AREA, 20. EROSION CONTROL NOTES DURING WINTER CONSTRUCTION WORK AREA APPROXIMATELY 12" APART ACROSS ENTIRE BLANKET WIDTH. 21. WINTER CONSTRUCTION PERIOD: NOVEMBER 1 THROUGH APRIL 15. ALL MATERIAL TO MEET MANUFACTURER SPECIFICATIONS 6. PLACE STAPLES/STAKES PER MANUFACTURER'S RECOMMENDATION FOR THE APPROPRIATE SLOPE STORE: COMPOST FILTER SOCK FILL TO MEET APPLICATION 22. WINTER EXCAVATION AND EARTHWORK SHALL BE DONE SUCH THAT THE AMOUNT OF AREA OPEN AT ONE TIME IS MINIMIZED TO THE 7. IN LOOSE SOIL CONDITIONS, THE USE OF STAPLE OR STAKE LENGTHS GREATER THAN 6" MAY BE PROTOTYPE 6-V-AV MAXIMUM EXTENT PRACTICABLE AND IN CONFORMANCE WITH THE STORMWATER POLLUTION PREVENTION PLAN SUCH THAT NECESSARY TO PROPERLY SECURE THE BLANKETS. . COMPOST MATERIAL TO BE DISPERSED ON SITE AT RESTAURANT #RC1233 ADEQUATE PROVISIONS ARE EMPLOYED TO CONTROL STORMWATER RUNOF COMPLETION OF CONSTRUCTION OR AS DIRECTED BY OWNER ALL MATERIAL TO MEET MANUFACTURER SPECIFICATIONS. AFTER STABILIZATION IS ACHIEVED. 23. CONTINUATION OF EARTHWORK OPERATION ON ADDITIONAL AREAS SHALL NOT BEGIN UNTIL THE EXPOSED SOIL SURFACE ON THE FILTER MEDIA TO MEET APPLICATION REQUIREMENTS. **DESIGNER INFORMATION:** AREA BEING WORKED HAS BEEN STABILIZED SUCH THAT NO LARGER AREA OF THE SITE IS WITHOUT EROSION CONTROL PROTECTION FILTER MEDIA TO BE DISPERSED ON SITE AT COMPLETION OF OR APPROVED CONSTRUCTION AFTER STABILIZATION IS ACHIEVED. AS **EQUIVALENT EQUIVALENT** DETERMINED BY ENGINEER IN OWNER AN AREA SHALL BE CONSIDERED TO HAVE BEEN TEMPORARILY STABILIZED WHEN EXPOSED SURFACES HAVE BEEN EITHER MULCHED **COMPOST FILTER SOCK** WITH STRAW OR STRAW AT A RATE OF 100 LB. PER 1,000 SQUARE FEET (WITH OR WITHOUT SEEDING) OR DORMANT SEEDED, **COMPOST FILTER SOCK EROSION CONTROL BLANKET STEEP SLOPE PROTECTION** MULCHED AND ADEQUATELY ANCHORED BY AN APPROVED ANCHORING TECHNIQUE IN PAVED CONDITION FOR AREAS WHERE CONSTRUCTION ACTIVITIES HAVE CEASED FOR A PERIOD EXCEEDING 14 DAYS BETWEEN THE DATES OF 352 TURNPIKE ROAD, 3rd FLOOR NOT TO SCALE NOT TO SCALE (NF-O040201 - 09/2023) NOT TO SCALE NF-0049901 - 09/2023) (NF-O040202 - 09/2023) NOVEMBER 1ST AND APRIL 1ST, LOAM OR SEED WILL NOT BE REQUIRED. THE SLOPES SHALL BE FINE GRADED AND EITHER PROTECTED WITH MULCH OR TEMPORARILY SEEDED. IF THE EXPOSED AREA HAS BEEN LOAMED, FINAL GRADED AND IS SMOOTH, SOUTHBOROUGH, MA 01772 SECURE LIFTING LOOPS TO OR UNDER SURFACE THEN THE AREA MAY BE DORMANT SEEDED AT A RATE OF 200-300% HIGHER THAN SPECIFIED FOR PERMANENT SEED AND THEN Phone: (508) 480-9900 MULCHED AS APPLICABLE SLOPES SHALL NOT BE LEFT UNSTABILIZED OVER THE WINTER OR IN AREAS WHERE WORK HAS CEASED FINISHED GRADE -FOR MORE THAN 14 DAYS UNLESS TREATED IN THE ABOVE MANNER. UNTIL SUCH TIME AS WEATHER CONDITIONS ALLOW DITCHES TO www.BohlerEngineering.com BE FINISHED WITH THE PERMANENT SURFACE TREATMENT, EROSION SHALL BE CONTROLLED BY THE INSTALLATION OF SEDIMENT 2" X 2" X 3/4" BARRIERS OR STONE CHECK DAMS IN ACCORDANCE WITH THE STANDARD DETAILS. RUBBER BLOCK . MULCHING REQUIREMENTS: 1/4" BRIGHTLY a) BETWEEN THE DATES OF NOVEMBER 1ST AND APRIL 15TH ALL MULCH SHALL BE ANCHORED BY EITHER PEG LINE, MULCH NETTING COLORED NYLON ROPE EXPANSION RESTRAIN b) MULCH NETTING SHALL BE USED TO ANCHOR MULCH IN ALL DRAINAGE WAYS WITH A SLOPE GREATER THAN 3% FOR SLOPE EXPOSED TO DIRECT WINDS AND FOR ALL OTHER SLOPES GREATER THAN 8%. MULCH NETTING SHALL BE USED TO ANCHOR MULCH IN ALL AREAS WITH SLOPES GREATER THAN 15%. AFTER OCTOBER 1ST THE SAME APPLIES FOR ALL SLOPES GREATER THAN 8%. **SECTION VIEW** ALL DISTURBED AREAS SHALL BE STABILIZED IN ACCORDANCE WITH THE STORMWATER PREVENTION PLAN. PROFILE VIEW OF INSTALLED FILTER SACK 28. DURING THE WINTER CONSTRUCTION PERIOD ALL SNOW SHALL BE REMOVED FROM AREAS OF SEEDING AND MULCHING PRIOR TO LOOPS SIZED FOR 1" APPARENT OPENING SIZE REBAR, LIFT FILET BAG FROM INLET USING MAINE LICENSE No. 12553 REBAR FOR HANDLES OVERFLOW HOLES -GEOTEXTILE BAG -CONSTRUCT SILT FENCE AND MIN 6" -**EROSION AND** 1/4" BRIGHTI Y COLORED -TRAPEZOID TEAR COMPOST FILTER SOCK AROUND NYLON ROPE EXPANSION RESTRAINT SEDIMENT LOOPS SIZED FOR 1" REBAR LISE -**CONTROL** REBAR FOR HANDLE TO EMPTY FILTER SACK AT A SEDIMENT COLLECTION LOCATION. **NOTES AND** REMOVE TRAPPED SEDIMENT WHEN BRIGHTLY COLORED EXPANSION RESTRAINT CAN NO LONGER BE SEEN. GEOTEXTILE SHALL BE A WOVEN POLYPROPYLENE FABRIC THAT MEETS OR EXCEEDS REQUIREMENTS IN **DETAILS** HE SPECIFICATIONS TABLE. PLACE AN OIL ADSORBENT PAD OR PILLOW OVER INLET GRATE WHEN OIL SPILLS ARE A CONCERN. INSPECT PER REGULATORY REQUIREMENTS. THE WIDTH, "W", OF THE FILTER SACK SHALL MATCH THE INSIDE WIDTH OF THE GRATED INI FT ROX THE DEPTH, "D", OF THE FILTER SACK SHALL BE BETWEEN 18 INCHES AND 36 INCHES. OR APPROVED THE LENGTH, "L", OF THE FILTER SACK SHALL MATCH THE INSIDE LENGTH OF THE GRATED INLET BOX. **EQUIVALENT** TEMPORARY STOCK PILE WITH INLET PROTECTION WITH MANUFACTURED INSERT SILT FENCE AND FILTER SOCK **REVISION 1 - 10/22/2024** (NE-O050101 - 09/2023)

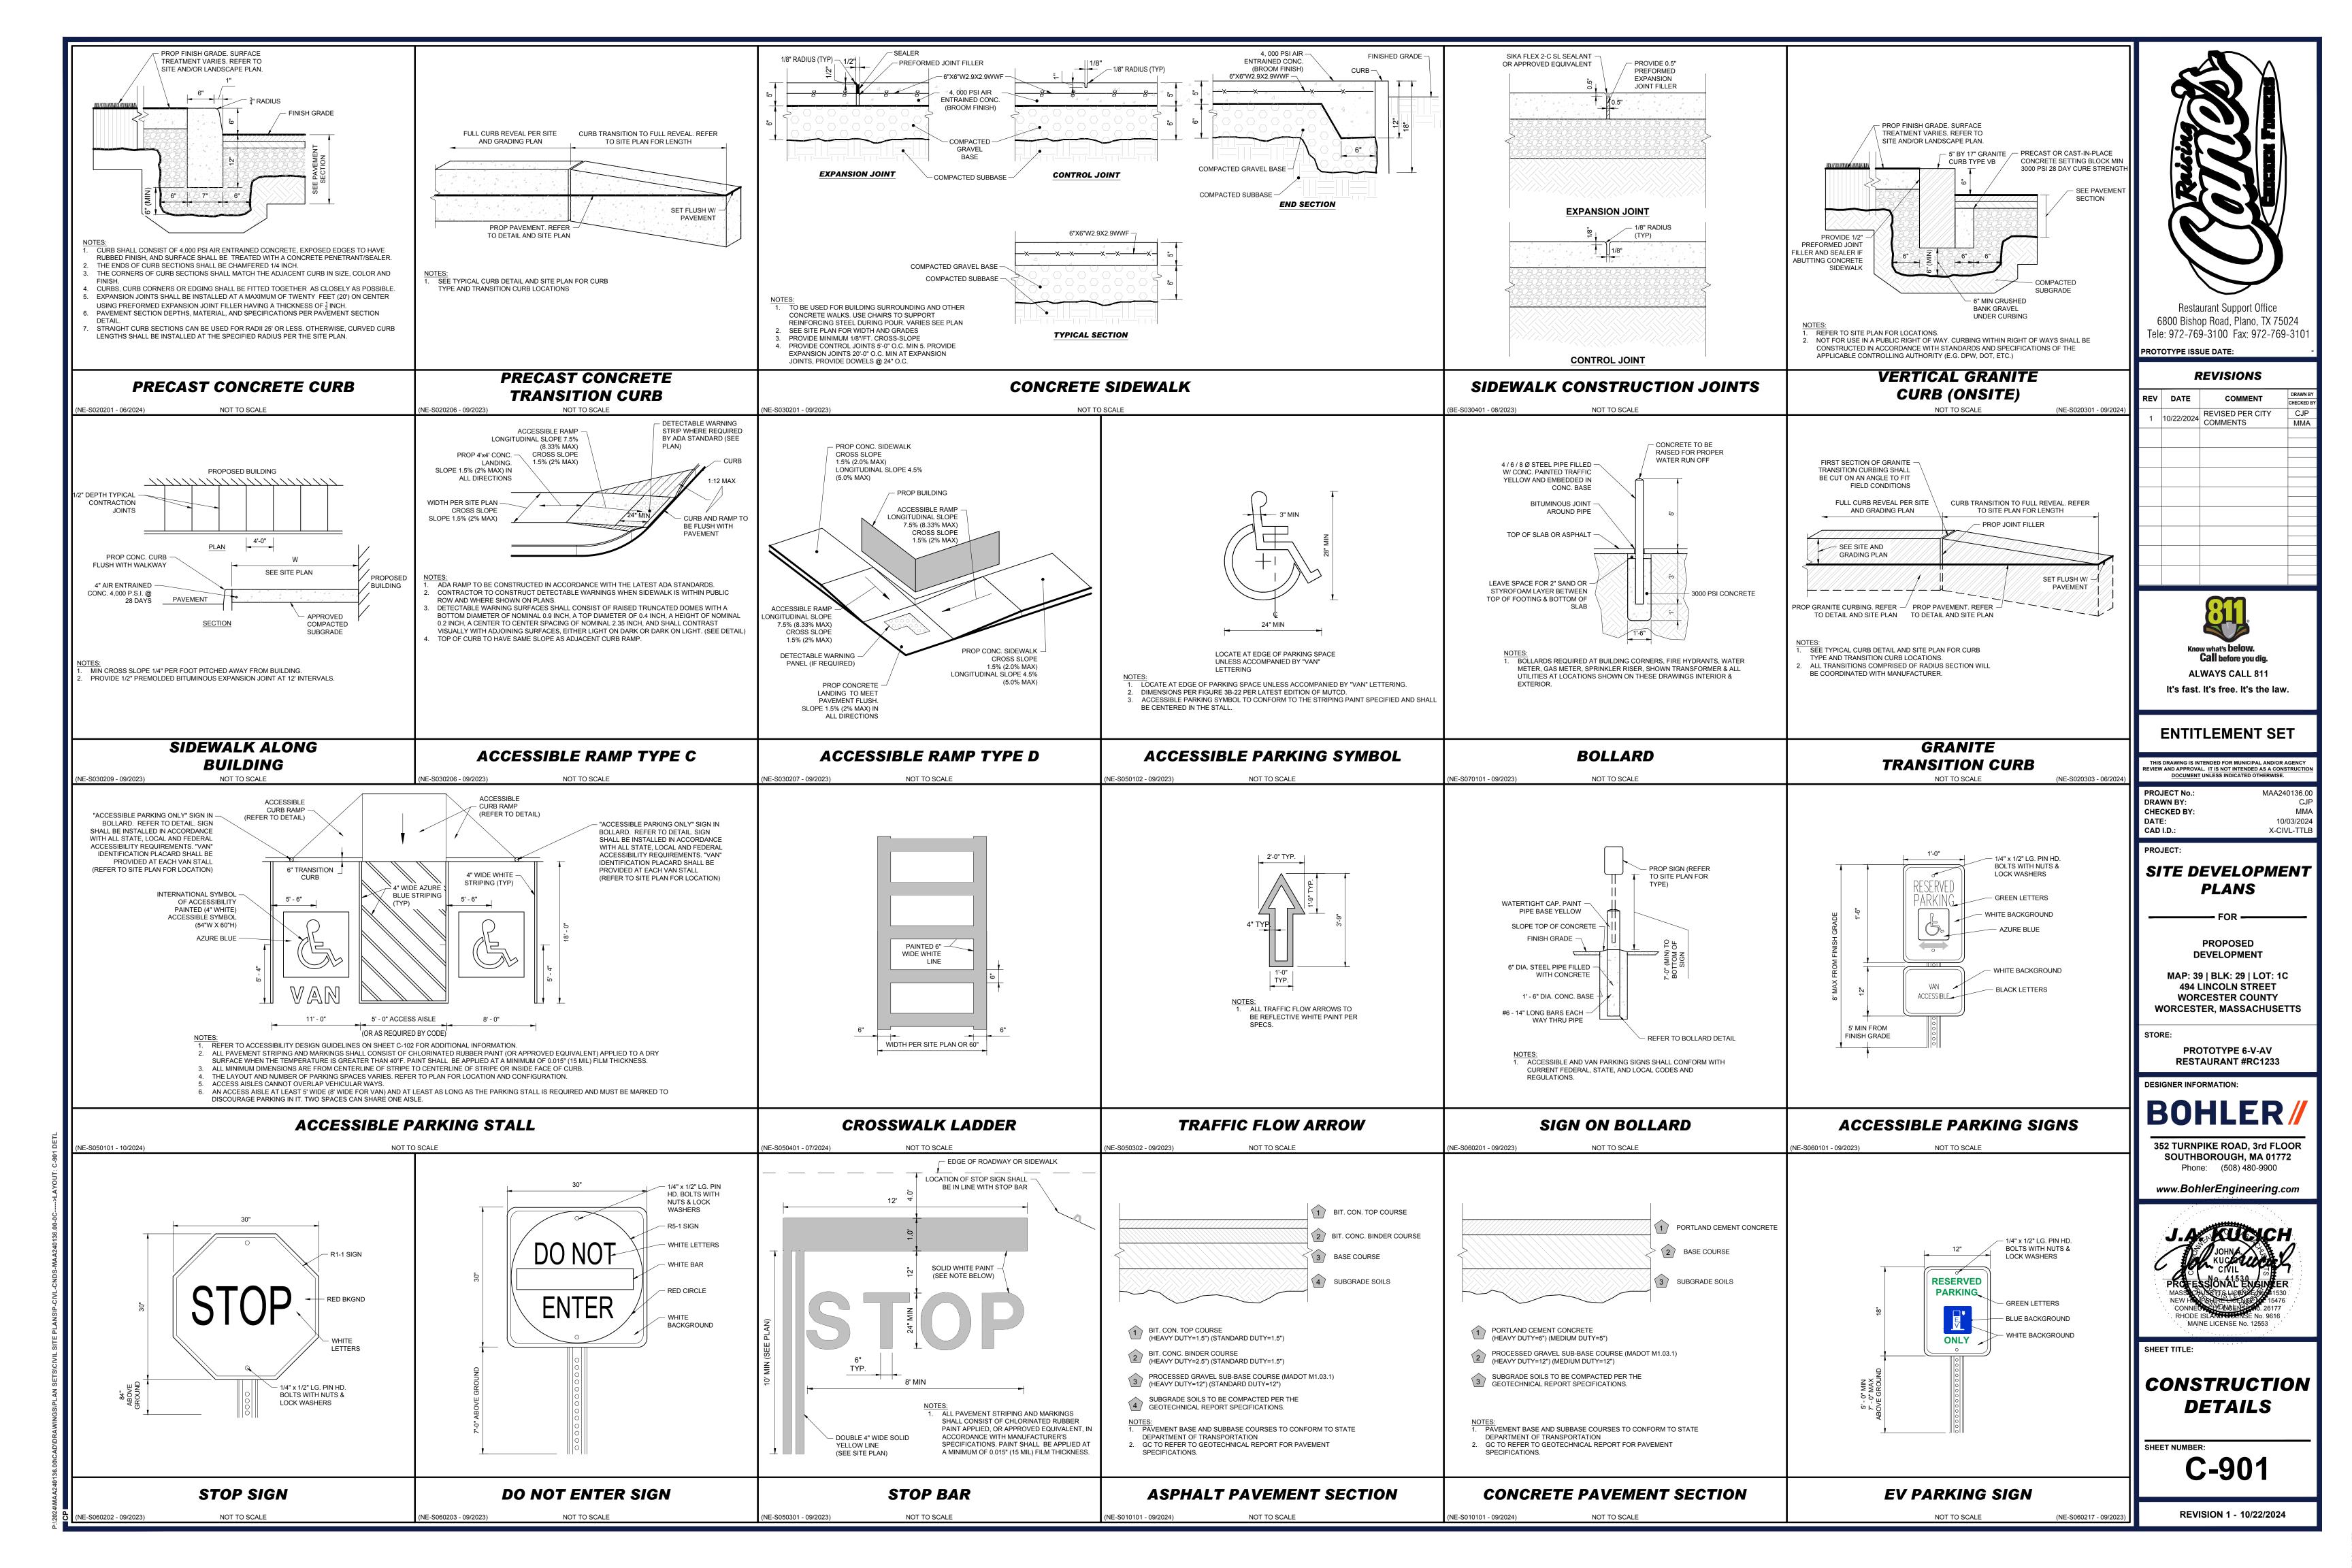

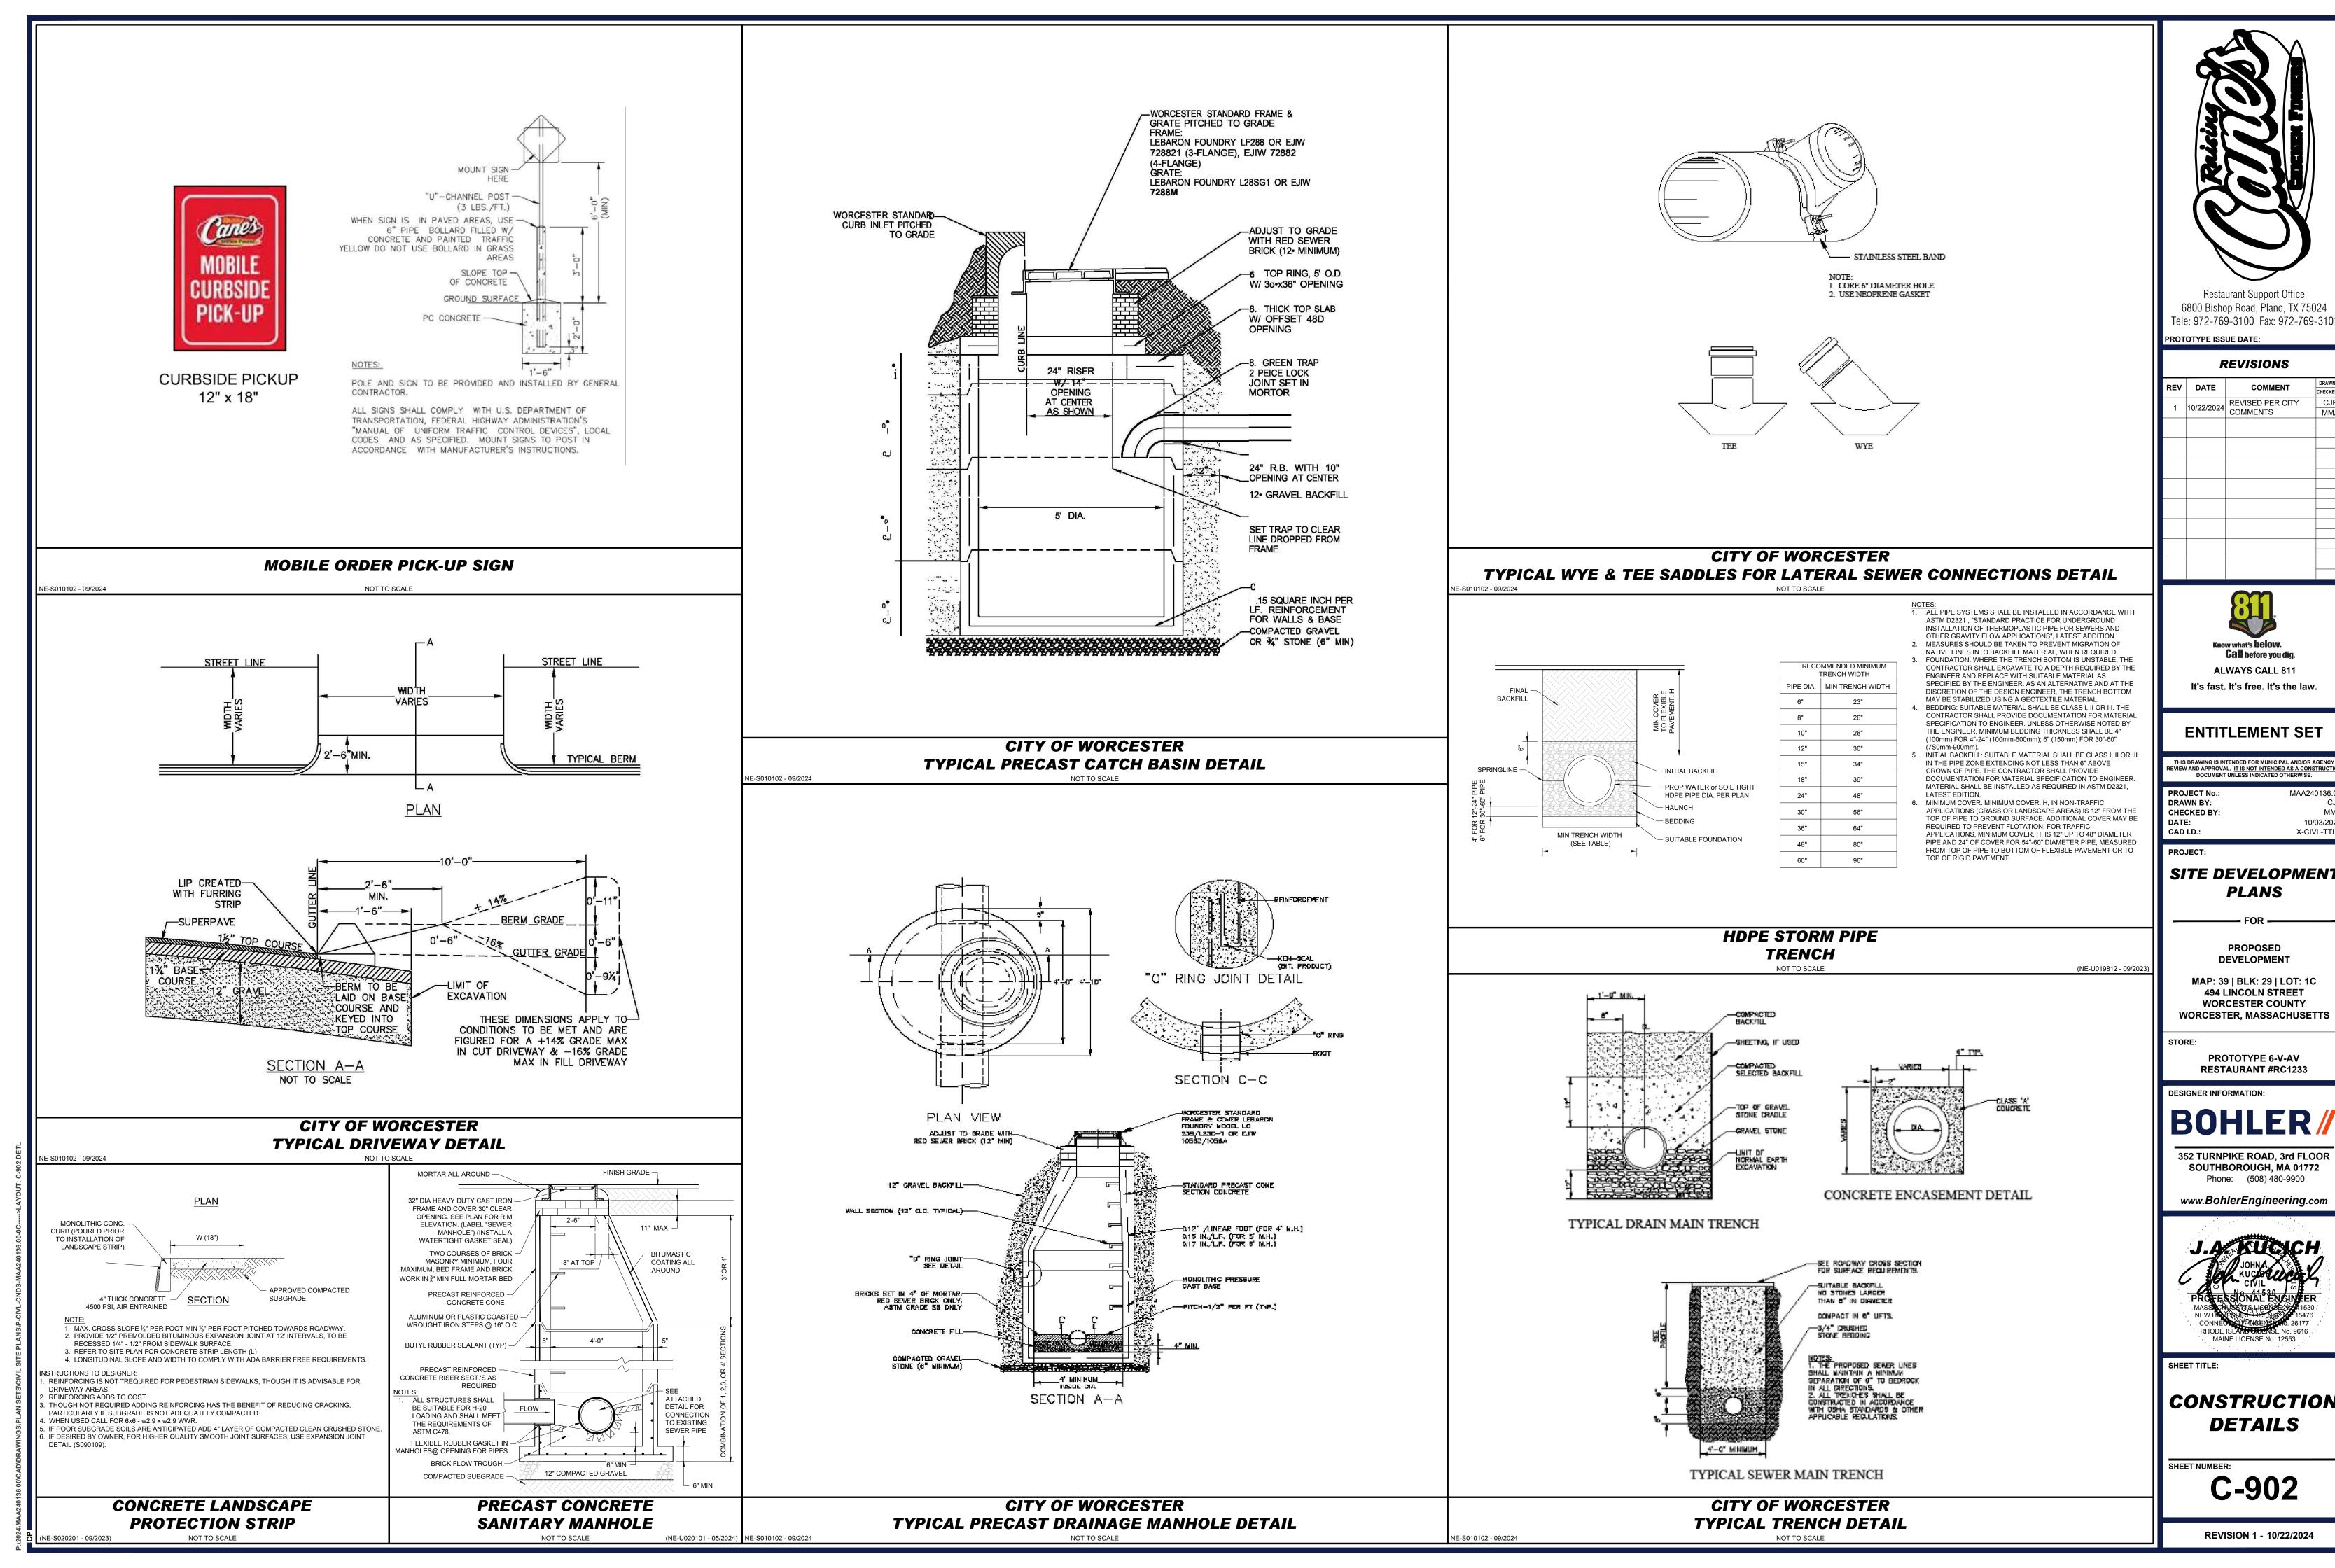



6800 Bishop Road, Plano, TX 75024

PROTOTYPE ISSUE DATE:

### **REVISIONS**

REV	DATE	COMMENT	DRAWN BY
1	10/22/2024	REVISED PER CITY	CJP
'	10/22/2024	COMMENTS	MMA



**ALWAYS CALL 811** 

It's fast. It's free. It's the law.

### **ENTITLEMENT SET**

THIS DRAWING IS INTENDED FOR MUNICIPAL AND/OR AGENCY REVIEW AND APPROVAL. IT IS NOT INTENDED AS A CONSTRUCTIC DOCUMENT UNLESS INDICATED OTHERWISE.

X-CIVL-TTLB

## SITE DEVELOPMENT

PROPOSED

MAP: 39 | BLK: 29 | LOT: 1C 494 LINCOLN STREET **WORCESTER COUNTY** 

PROTOTYPE 6-V-AV **RESTAURANT #RC1233** 


352 TURNPIKE ROAD, 3rd FLOOR SOUTHBOROUGH, MA 01772


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CONSTRUCTION **DETAILS** 

C-902





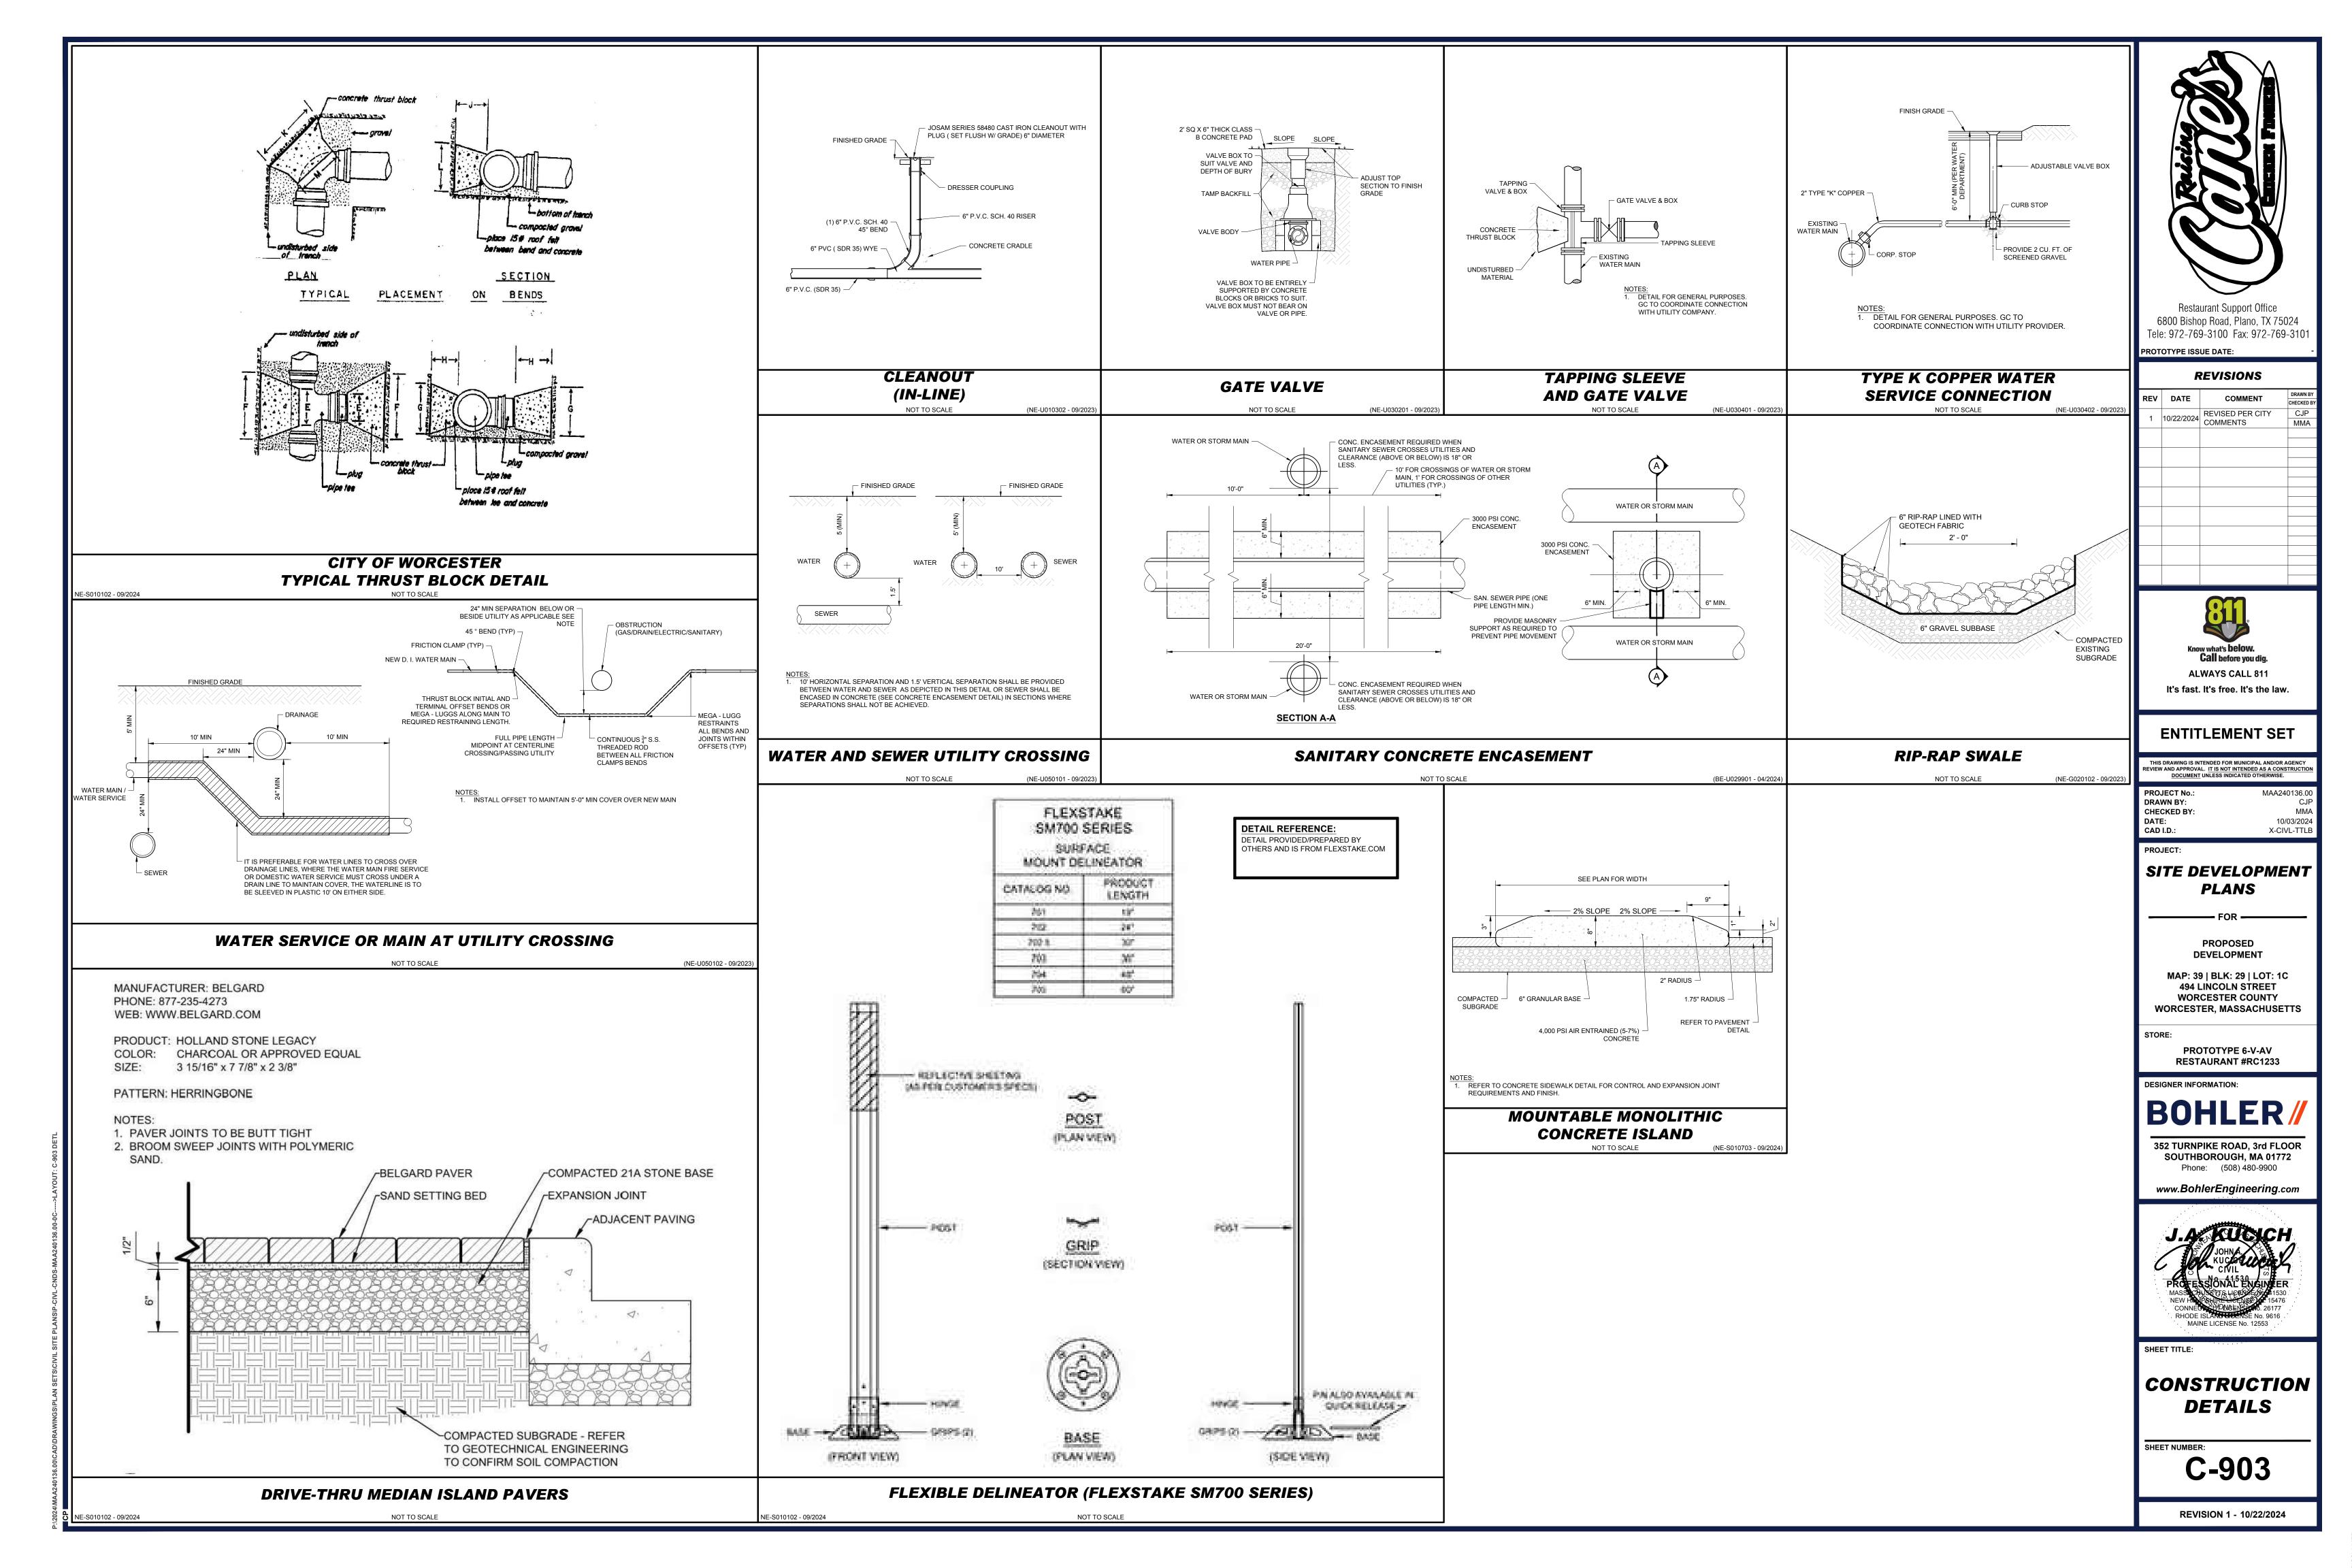

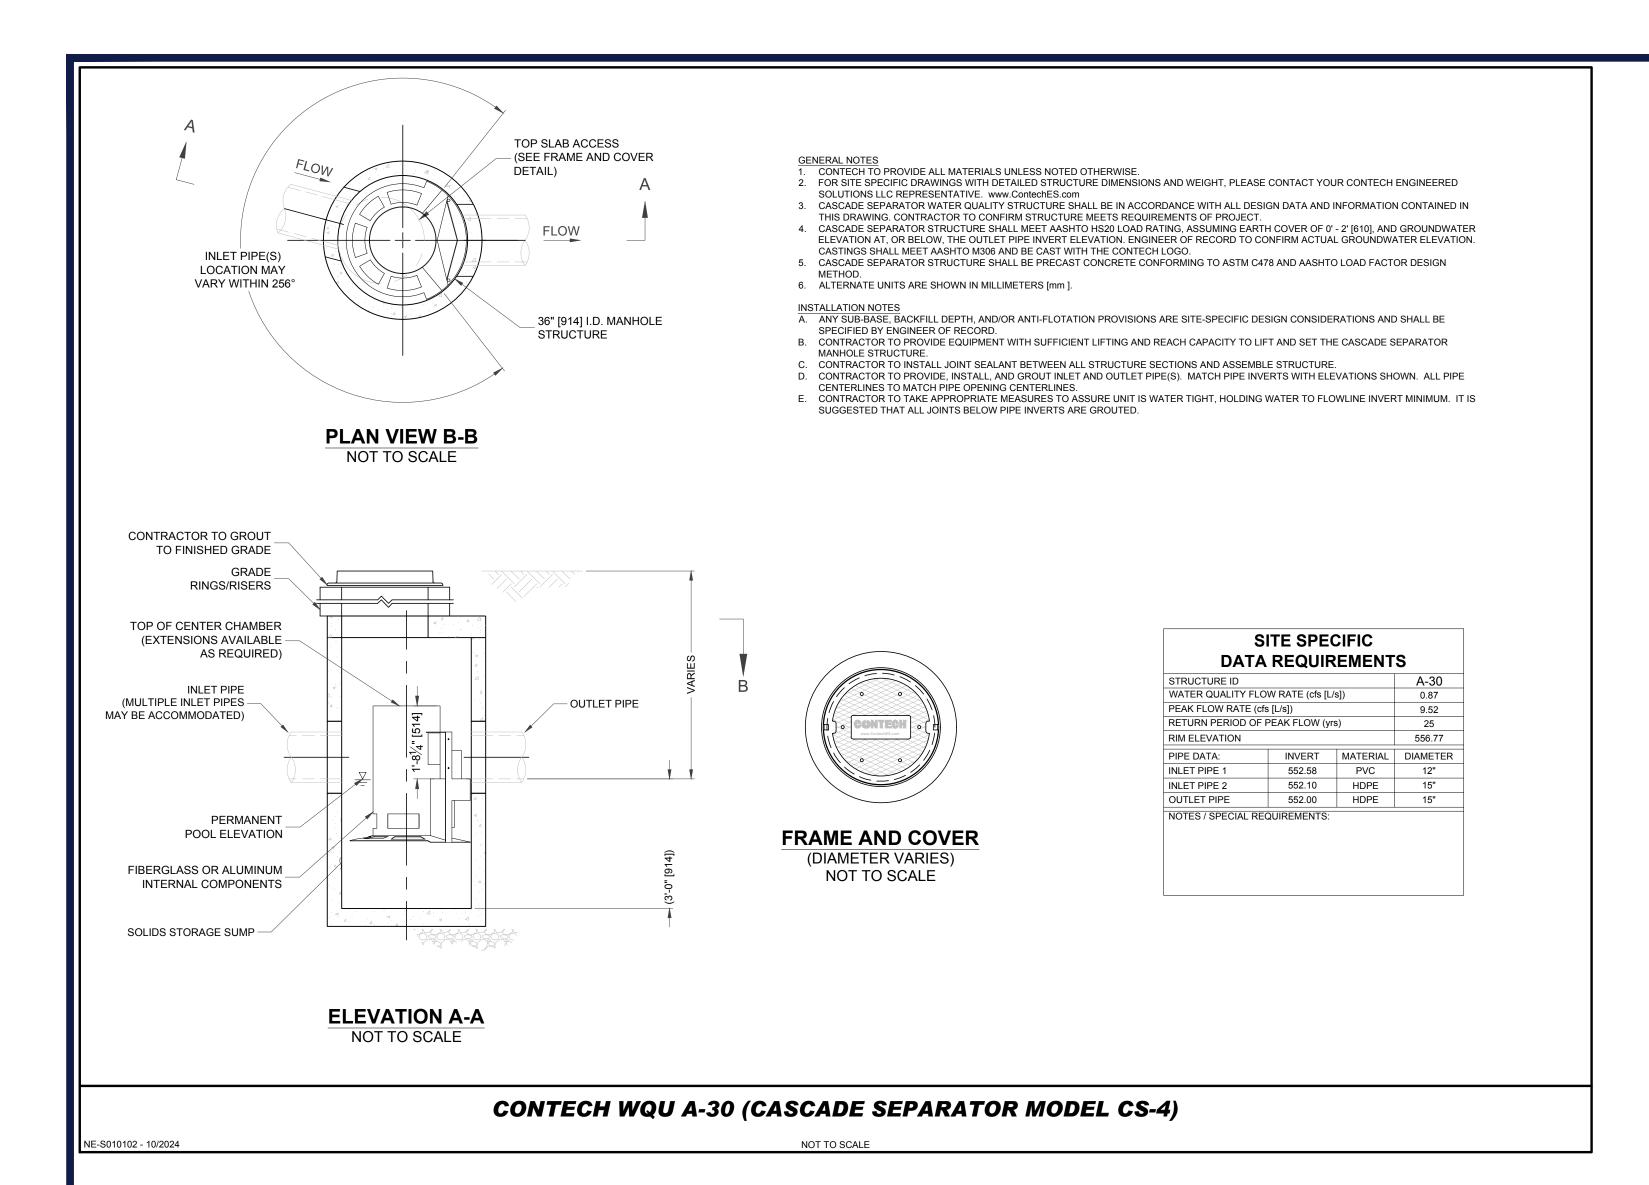Restaurant Support Office 6800 Bishop Road, Plano, TX 75024 Tele: 972-769-3100 Fax: 972-769-3101

PROTOTYPE ISSUE DATE:

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'	10/22/2024	COMMENTS	MMA



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### **ENTITLEMENT SET**

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10/03/2024 X-CIVL-TTLB

PROJECT No.: MAA240136.

DRAWN BY: CHECKED BY: MI

DATE: CAD I.D.:

## SITE DEVELOPMENT PLANS

PROPOSED DEVELOPMENT

MAP: 39 | BLK: 29 | LOT: 1C 494 LINCOLN STREET WORCESTER COUNTY WORCESTER, MASSACHUSETTS

ORE:


PROTOTYPE 6-V-AV RESTAURANT #RC1233

DESIGNER INFORMATION:

## BOHLER/

352 TURNPIKE ROAD, 3rd FLOOR SOUTHBOROUGH, MA 01772 Phone: (508) 480-9900

www.BohlerEngineering.com

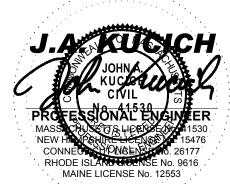


SHEET TITLE:

# CONSTRUCTION DETAILS

JEET NIIMBED


C-904

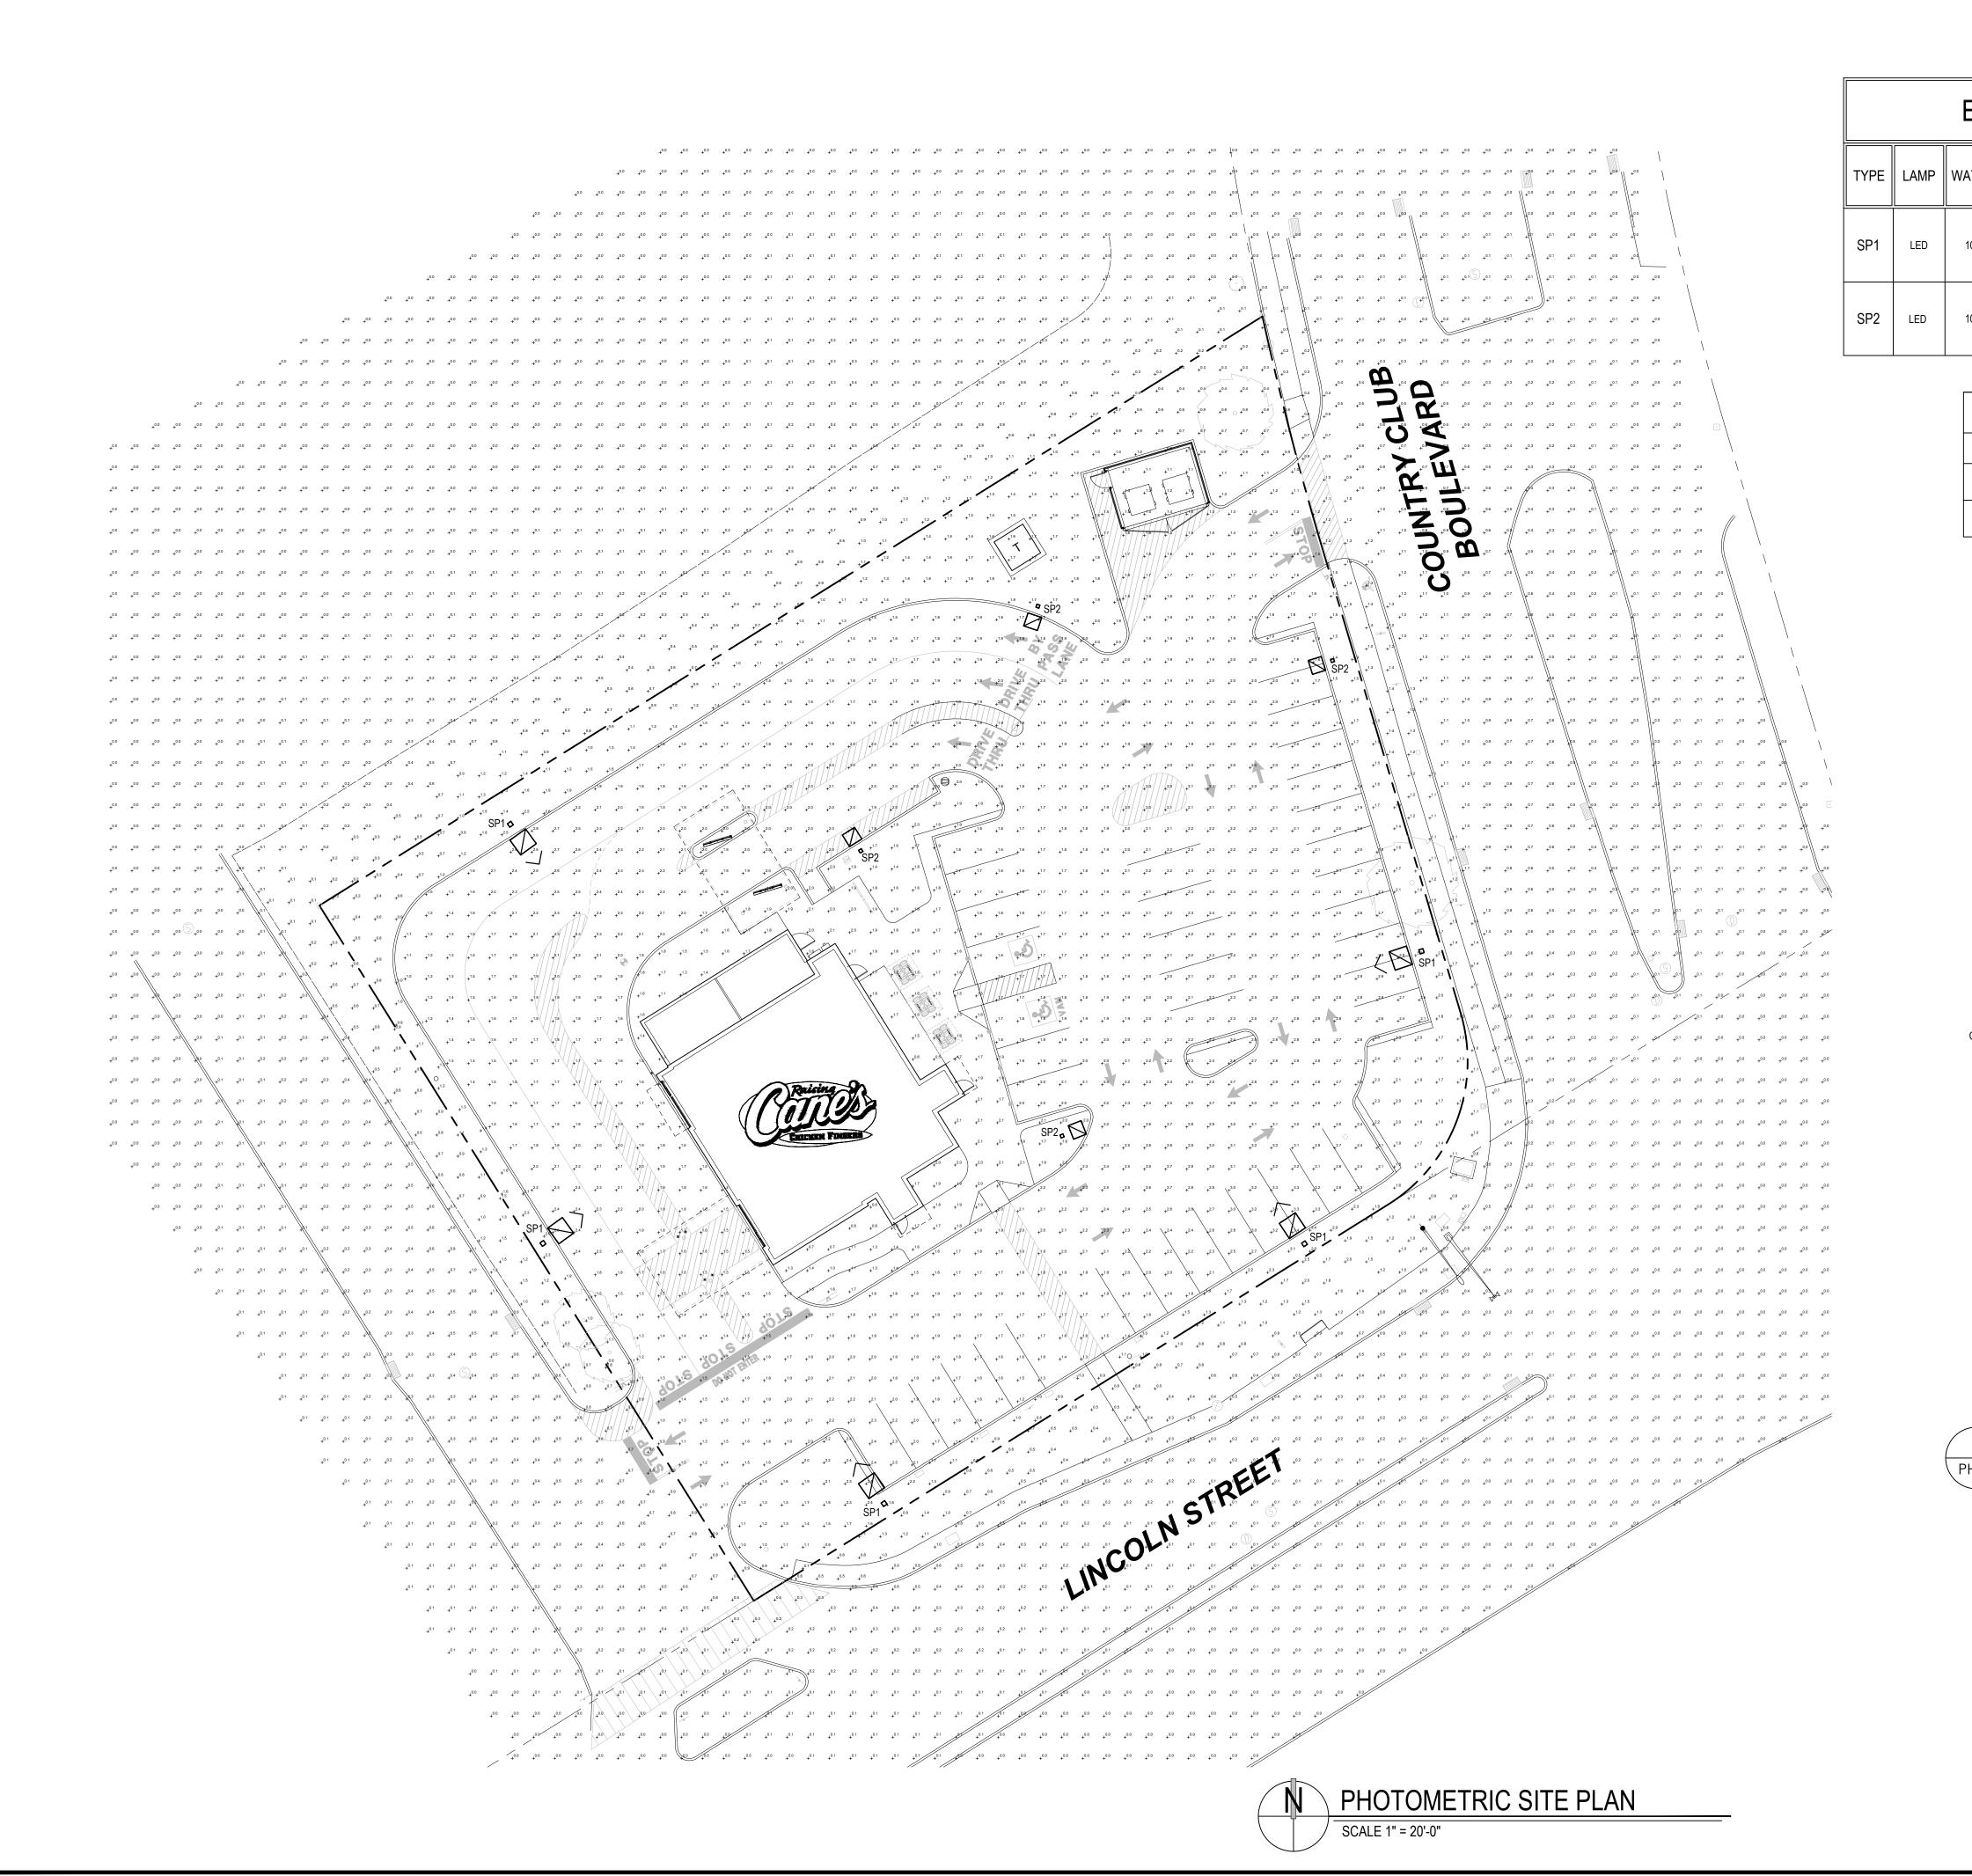

## EXTERIOR LIGHTING FIXTURE SCHEDULE

TYPE	LAMP	WATTS	DESCRIPTION	CATALOG NO.
SP1	LED	102	LED POLE MOUNTED FIXTURE WITH TYPE IV MEDIUM DISTRIBUTION & DARK BRONZE FINISH. MOUNTED ON A 20' TALL SQUARE STRAIGHT STEEL POLE.	LITHONIA#  DSX1-LED-P3-30K-T4M-MVOLT-  SPA-DDBXD  POLE - LITHONIA#  SSS-20'-5G-DM19AS-DDBXD
SP2	LED	102	LED POLE MOUNTED FIXTURE WITH TYPE V MEDIUM DISTRIBUTION & DARK BRONZE FINISH. MOUNTED ON A 20' TALL SQUARE STRAIGHT STEEL POLE.	LITHONIA# DSX1-LED-P3-30K-T5M-MVOLT- SPA-DDBXD POLE - LITHONIA# SSS-20'-5G-DM19AS-DDBXD

STATISTICS	(VALUES ARE MAINTA				
Description	Avg	Max	Min	Max/Min	Avg/Min
PARKING FIELD	2.0 fc	3.4 fc	0.9 fc	3.8:1	2.2:1
PROPERTY LINE	0.1 fc	1.6 fc	0.0 fc	N/A	N/A

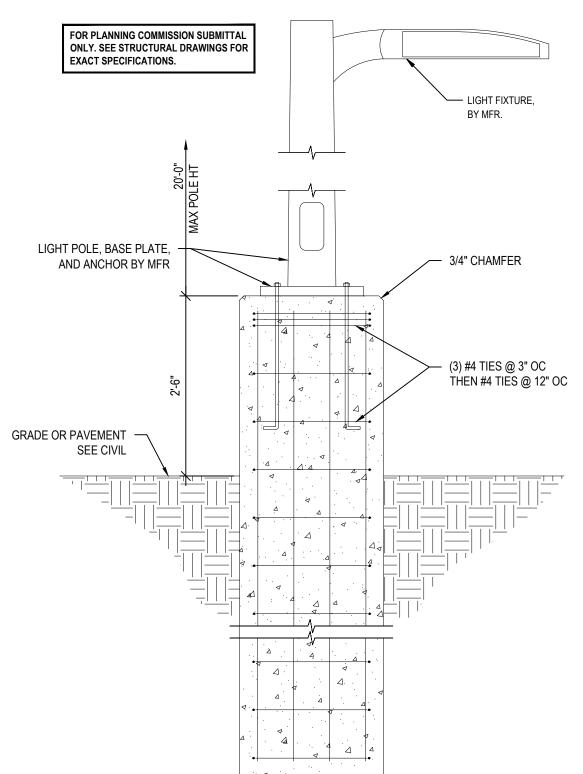

TYPICAL LIGHT POLE BASE DETAIL PH1.0 | SCALE: 3/4"=1'-0"



RAISING CANE'S RESTAURANT 494 LINCOLN ST. WORCESTER, MA 01605 PROTOTYPE: P6-V-Av SCHEME: B RESTAURANT #RC1233

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ENGINEER INFORMATION:

SHEET REVISIONS # DATE TYPE

PHOTOMETRIC SITE PLAN

10/1/2024 DATE: 24164 JOB NO.

SHEET NO.



a high performance, high efficacy, long-life Length: luminaire. Height H2

The photometric performance results in sites with excellent uniformity, greater pole spacing and lower power density. D-Series outstanding photometry aids in reducing the number of poles required in area lighting applications with typical energy savings of 65% and expected service life of over 100,000 hours.

DSX1 LED	P3	30K	70CRI	T4M		MVOLT	SPA
Series	LEDs	Color temperature <sup>2</sup>	Color Rendering Index <sup>2</sup>	Distribution		Voltage	Mounting
DSX1 LED	Forward optics P1 P6 P2 P7 P3 P8 P4 P9 P5 Rotated optics P10 P12 P11 P13 P13 P13 P13 P13 P13 P13 P13 P13	30K 3000K 40K 4000K 50K 5000K (this section 80CRI only, extended lead times apply)	70CRI 70CRI 70CRI 80CRI 80CRI 80CRI 80CRI 80CRI	AFR Automotive front row T1S Type I short T2M Type II medium T3M Type III medium T3LG Type III low glare <sup>3</sup> T4M Type IV medium T4LG Type IV low glare <sup>3</sup> TFTM Forward throw medium	T5M Type V medium T5LG Type V low glare T5W Type V wide BLC3 Type III backlight control 3 BLC4 Type IV backlight control 3 LCCO Left corner cutoff 3 RCCO Right corner cutoff 3	MVOLT (120V-277V) <sup>4</sup> HVOLT (347V-480V) <sup>5,6</sup> XVOLT (277V - 480V) <sup>7,8</sup> 120 <sup>16, 26</sup> 208 <sup>16, 26</sup> 240 <sup>16, 26</sup> 277 <sup>16, 26</sup> 347 <sup>16, 26</sup> 480 <sup>16, 26</sup>	Shipped included  SPA Square pole mounting (#8 drilling)  RPA Round pole mounting (#8 drilling)  SPAS Square pole mounting #5 drilling 9  RPA5 Round pole mounting #5 drilling 9  SPA8N Square narrow pole mounting #8 drilling  WBA Wall bracket 10  MA Mast arm adapter (mounts on 2 3/8" 0D horizontal tenon)

1	I	1	I		d <sub>i</sub>	- 1	,
						DDBX	)
Control options				Other optic	ons	Finish (requ	iired)
Shipped installe NLTAIR2 PIRHN PIR PER PER5	nLight AIR gen 2 enabled with bi-level motion / ambient sensor, 8-40' mounting height, ambient sensor enabled at 2fc. 11, 12, 20, 21 High/low, motion/ambient sensor, 8-40' mounting height, ambient sensor enabled at 2fc 13, 20, 21 NEMA twist-lock receptacle only (controls ordered separate) 14 Five-pin receptacle only (controls ordered separate) 14	PER7 FAO BL30 BL50 DMG	Seven-pin receptacle only (controls ordered separate) <sup>14,21</sup> Field adjustable output <sup>15,21</sup> Bi-level switched dimming, 30% <sup>16,21</sup> Bi-level switched dimming, 50% <sup>16,21</sup> 0–10v dimming wires pulled outside fixture (for use with an external control, ordered separately) <sup>17</sup> Dual switching <sup>18, 19,21</sup>	Shipped in SPD20KV HS L90 R90 CCE HA BAA SF DF Shipped s EGSR	20KV surge protection Houseside shield (black finish standard) <sup>22</sup> Left rotated optics <sup>1</sup> Right rotated optics <sup>1</sup> Coastal Construction <sup>23</sup> 50°C ambient operation <sup>24</sup> Buy America(n) Act Compliant Single fuse (120, 277, 347V) <sup>26</sup> Double fuse (208, 240, 480V) <sup>26</sup>	DDBXD DBLXD DNAXD DWHXD DDBTXD DBLBXD DNATXD DWHGXD	Dark Bronze Black Natural Aluminum White Textured dark bronze Textured black Textured natural aluminum Textured white

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### **D-Series Size 1** LED Area Luminaire Introduction The modern styling of the D-Series features a highly refined aesthetic that blends seamlessly **Specifications** with its environment. The D-Series offers the benefits of the latest in LED technology into a high performance, high efficacy, long-life luminaire. 14.26" (36.2 cm) The photometric performance results in sites with excellent uniformity, greater pole spacing 7.88" (20.0 cm) and lower power density. D-Series outstand-ing photometry aids in reducing the number of Height H2: poles required in area lighting applications with 34 lbs typical energy savings of 65% and expected service life of over 100,000 hours. **EXAMPLE:** DSX1 LED P7 40K 70CRLT3M MVOLT SPA NITAIR2 PIRHN DDRXD

Number Fixture Type SP2

OSX1 LED	P3	30K	70CRI	T5M		MVOLT	SPA
eries	LEDs	Color temperature <sup>2</sup>	Color Rendering Index <sup>2</sup>	Distribution		Voltage	Mounting
DSX1 LED	Forward optics P1 P6 P2 P7 P3 P8 P4 P9 P5 Rotated optics P101 P121 P111 P131	(this section 70CRI only) 30K 3000K 40K 4000K 50K 5000K (this section 80CRI only, extended lead times apply) 27K 2700K 30K 3000K 35K 3500K 40K 4000K 50K 5000K	70CRI 70CRI 70CRI 80CRI 80CRI 80CRI 80CRI 80CRI	AFR Automotive front row T1S Type I short T2M Type II medium T3M Type III medium T3LG Type III low glare 3 T4M Type IV medium T4LG Type IV low glare 3 TFTM Forward throw medium	T5M Type V medium T5LG Type V low glare T5W Type V wide BLC3 Type III backlight control 3 BLC4 Type IV backlight control 3 LCC0 Left corner cutoff 3 RCC0 Right corner cutoff 3	MVOLT (120V-277V) <sup>4</sup> HVOLT (347V-480V) <sup>5,6</sup> XVOLT (277V - 480V) <sup>7,8</sup> 120 <sup>16, 26</sup> 208 <sup>16, 26</sup> 240 <sup>16, 26</sup> 277 <sup>16, 26</sup> 347 <sup>16, 26</sup> 480 <sup>16, 26</sup>	Shipped included  SPA Square pole mounting (#8 drilling)  RPA Round pole mounting (#8 drilling)  SPAS Square pole mounting #5 drilling?  RPA5 Round pole mounting #5 drilling?  SPA8N Square narrow pole mounting #8 drilling  WBA Wall bracket 10  MA Mast arm adapter (mounts on 2 3/8" OD horizontal tenon)
							DDBXD
ontrol opti	ons				Other options	F	inish (required)
<b>Shipped in:</b> NLTAIR2 PIR	HN nLight AIR gen 2 er	nabled with bi-level motion /	orde	en-pin receptacle only (controls red separate) <sup>14,21</sup>	Shipped installed SPD20KV 20KV surge protection		DDBXD Dark Bronze DBLXD Black

							horizontal tenon)
						DDBXI	כ
Control options				Other opti	ons	Finish (requ	uired)
Shipped installe NLTAIR2 PIRHN PIR PER PER5	nLight AIR gen 2 enabled with bi-level mot ambient sensor, 8-40' mounting height, am sensor enabled at 2fc. <sup>11, 12, 26, 21</sup> High/low, motion/ambient sensor, 8-40' mou height, ambient sensor enabled at 2fc <sup>13, 28, 21</sup> NEMA twist-lock receptacle only (controls o separate) <sup>14</sup> Five-pin receptacle only (controls ordered sep	pient FA BL Inting BL rdered DM	ordered separate) 14,21  Field adjustable output 15,21  Bi-level switched dimming, 30% 16,21  Bi-level switched dimming, 50% 16,21  O-10v dimming wires pulled outside fixture (for use with an external control, ordered separately) 17	Shipped i SPD20KV HS L90 R90 CCE HA BAA SF DF Shipped s EGSR	nstalled  20KV surge protection  Houseside shield (black finish standard) <sup>22</sup> Left rotated optics <sup>1</sup> Right rotated optics <sup>1</sup> Coastal Construction <sup>23</sup> 50°C ambient operation <sup>24</sup> Buy America(n) Act Compliant Single fuse (120, 277, 347V) <sup>26</sup> Double fuse (208, 240, 480V) <sup>26</sup> separately External Glare Shield (reversible, field install required, matches housing finish) Bird Spikes (field install required)	DDBXD DBLXD DNAXD DWHXD DDBTXD DBLBXD DNATXD DWHGXD	Dark Bronze Black Natural Aluminum White Textured dark bronze Textured black Textured natural aluminum Textured white

**Electrical Load** 

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Performance Data

Lumen Ambient Temperature (LAT) Multipliers

Use these factors to determine relative lumen output for average ambient temperatures from 0-40°C (32-104°F).

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formance LED Drive Wattage 120V 208V 240V 277V 347V 480V P1 30 530 51 0.42 0.24 0.21 0.18 0.15 0.11 P2 30 700 68 0.56 0.33 0.28 0.24 0.20 0.14 P3 30 1050 104 0.85 0.49 0.43 0.37 0.29 0.21 P4 30 1250 125 1.03 0.60 0.52 0.45 0.36 0.26 P5 30 1400 142 1.15 0.66 0.58 0.50 0.40 0.29 P6 40 1250 167 1.38 0.79 0.69 0.60 0.48 0.34 P7 40 1400 188 1.54 0.89 0.77 0.67 0.53 0.38 P8 60 1100 216 1.80 1.04 0.90 0.78 0.62 0.45

P9 60 1400 279 2.31 1.33 1.15 1.00 0.80 0.58 P10 60 530 101 0.84 0.49 0.42 0.37 0.29 0.21

P11 60 700 135 1.12 0.65 0.56 0.49 0.39 0.28

P12 60 1050 206 1.72 0.99 0.86 0.74 0.59 0.43 P13 60 1400 279 2.30 1.33 1.15 1.00 0.79 0.57

Lumen Multiplier Availability Lumen Multiplier Availability Lumen Multiplier Availability

**LED Color Temperature / Color Rendering Multipliers** 

Note: Some LED types are available as per special request. Contact Technical Support for more information

Orilling

Template #8

2.75" for other pole types

HANDHOLE ORIENTATION

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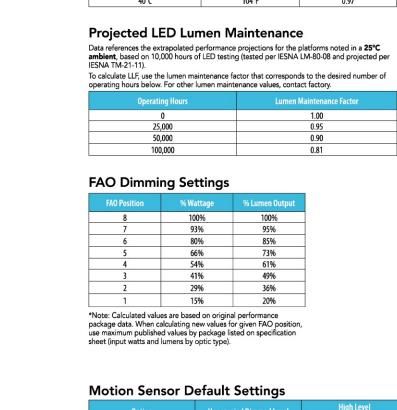
D (	<u> </u>	

Lumen Output Lumen values are from photometric tests performed in accordance with IESNA LM-79-08. Data is considered to be representative of configurations shown within the tolerances described within LM-79.

							30K		i.			40K					50K		
Performance	System Watts	LED Count	Drive	Distribution Type		(30	00K, 70	CRI)			(40	00K, 70	(CRI)			(50	00K, 70	CRI)	
Package			Current (mA)		Lumens	В	U	G	LPW	Lumens	В	U	G	LPW	Lumens	В	U	G	ī
				T1S	7,776	1	0	2	153	8,104	1	0	2	159	8,262	1	0	2	
				T2M	7,203	1	0	3	142	7,507	2	0	3	147	7,653	2	0	3	
				T3M	7,287	1	0	3	143	7,594	1	0	3	149	7,742	1	0	3	1
				T3LG	6,509	1	0	1	128	6,783	1	0	1	133	6,916	1	0	1	
				T4M	7,395	1	0	3	145	7,707	1	0	3	151	7,857	1	0	3	
				T4LG	6,726	1	0	1	132	7,010	1	0	1	138	7,146	1	0	1	
				TFTM	7,446	1	0	3	146	7,760	1	0	3	152	7,912	1	0	3	
P1	51W	30	530	T5M	7,609	3	0	2	149	7,930	3	0	2	156	8,084	3	0	2	
				T5W	7,732	3	0	2	152	8,058	4	0	2	158	8,215	4	0	2	
				T5LG	7,631	3	0	1	150	7,953	3	0	1	156	8,108	3	0	1	
				BLC3	5,300	0	0	2	104	5,524	0	0	2	109	5,631	0	0	2	
				BLC4	5,474	0	0	3	108	5,705	0	0	3	112	5,816	0	0	3	
				RCCO	5,348	0	0	2	105	5,573	0	0	2	109	5,682	0	0	2	
				LCC0	5,348	0	0	2	105	5,573	0	0	2	109	5,682	0	0	2	
				AFR	7,776	1	0	2	153	8,104	1	0	2	159	8,262	1	0	2	
				T1S	9,997	1	0	2	147	10,418	1	0	2	154	10,621	1	0	2	
				T2M	9,260	2	0	3	137	9,651	2	0	3	142	9,839	2	0	3	
				T3M	9,368	2	0	3	138	9,763	2	0	3	144	9,953	2	0	3	
				T3LG	8,368	1	0	2	123	8,721	1	0	2	129	8,891	1	0	2	
				T4M	9,507	2	0	3	140	9,909	2	0	3	146	10,102	2	0	3	
				T4LG	8,647	1	0	2	128	9,012	1	0	2	133	9,187	1	0	2	
				TFTM	9,573	2	0	3	141	9,977	2	0	3	147	10,172	2	0	3	1
P2	68W	30	700	T5M	9,782	4	0	2	144	10,195	4	0	2	150	10,393	4	0	2	0
				T5W	9,940	4	0	2	147	10,360	4	0	2	153	10,562	4	0	2	
				T5LG	9,810	3	0	1	145	10,224	3	0	1	151	10,423	3	0	1	
				BLC3	6,814	0	0	2	101	7,101	0	0	2	105	7,240	0	0	2	
				BLC4	7,038	0	0	3	104	7,334	0	0	3	108	7,477	0	0	3	
				RCCO	6,875	1	0	2	101	7,165	1	0	2	106	7,305	1	0	2	- 8
				LCC0	6,875	1	0	2	101	7,165	1	0	2	106	7,305	1	0	2	77
				AFR	9,997	1	0	2	147	10,418	1	0	2	154	10,621	1	0	2	
				T1S	14,093	2	0	2	138	14,687	2	0	2	144	14,973	2	0	2	
				T2M	13,055	2	0	3	128	13,605	2	0	3	133	13,871	2	0	3	
				T3M	13,206	2	0	4	129	13,763	2	0	4	135	14,031	2	0	4	
				T3LG	11,797	2	0	2	115	12,294	2	0	2	120	12,534	2	0	2	
				T4M	13,403	2	0	4	131	13,968	2	0	4	137	14,241	2	0	4	
				T4LG	12,190	2	0	2	119	12,704	2	0	2	124	12,952	2	0	2	
				TFTM	13,496	2	0	4	132	14,065	2	0	4	138	14,339	2	0	4	
P3	102W	30	1050	T5M	13,790	4	0	2	135	14,371	4	0	2	141	14,652	4	0	2	
				T5W	14,013	4	0	3	137	14,605	4	0	3	143	14,889	4	0	3	
				T5LG	13,830	3	0	2	135	14,413	3	0	2	141	14,694	3	0	2	
				BLC3	9,606	0	0	2	94	10,011	0	0	2	98	10,206	0	0	2	
				BLC4	9,921	0	0	3	97	10,340	0	0	3	101	10,541	0	0	3	

Photometric Diagrams To see complete photometric reports or download .ies files for this product, visit Lithonia Lighting's homepage. Isofootcandle plots for the DSX1 LED P9 40K 70CRI. Distances are in units of mounting height (25').

END	6 5 4 3 2 1 0 1 2 3 4 5 6	6 5 4 3 2 1 0 1 2 3 4 5 6	6 5 4 3 2 1 0 1 2 3 4 5 6	6 5 4 3 2 1 0 1 2 3 4 5 6
0.1 fc 0.5 fc 1.0 fc	4 3 2 1 1 1 1 1 1 1 1 1 1 1 1 1 1 1 1 1 1	6 5 4 9 9 9 9 9 9 9 9 9 9 9 9 9 9 9 9 9 9	6 5 4 3 2 2 1 1 1 2 2 3 4 4 5 5 6 6 T3M	6 5 4 3 2 1 1 1 1 1 1 1 1 1 1 1 1 1 1 1 1 1 1
	6 5 4 3 2 1 0 1 2 3 4 5 6  6 5 4 3 2 1 0 1 2 3 4 5 6  6 1 1 1 1 1 1 1 1 1 1 1 1 1 1 1 1 1	6 5 4 3 2 1 0 1 2 3 4 5 6 6 5 4 3 2 1 1 0 1 2 3 4 5 6 TFTM	6 5 4 3 2 1 0 1 2 3 4 5 6  6 5 4 3 2 1 0 1 2 3 4 5 6  744  75  6 744  744  744	6 5 4 3 2 1 0 1 2 3 4 5 6  6 5 4 3 2 1 0 1 2 3 4 5 6  7 5 4 5 5 6 T T S M
	6 5 4 3 2 1 0 1 2 3 4 5 6 6 5 4 3 2 1 0 1 2 3 4 5 6 4 3 2 1 0 1 2 3 4 5 6	6 5 4 3 2 1 0 1 2 3 4 5 6  6 5 4 3 2 1 0 1 2 3 4 5 6  7 5 4 4 5 5 6 7 5 LG	6 5 4 3 2 1 0 1 2 3 4 5 6 6 5 4 3 2 1 0 1 2 3 4 5 6 7 7 8 9 9 9 9 9 9 9 9 9 9 9 9 9 9 9 9 9	6 5 4 3 2 1 0 1 2 3 4 5 6  6 5 4 3 2 1 0 1 2 3 4 5 6  7 7 8 9 9 9 9 9 9 9 9 9 9 9 9 9 9 9 9 9
	6 5 4 3 2 1 0 1 2 3 4 5 6	6 5 4 3 2 1 0 1 2 3 4 5 6	6 5 4 3 2 1 0 1 2 3 4 5 6	



t (input watts and lumens by	input watts and lumens by optic type).									
otion Sensor D	tion Sensor Default Settings									
Option	Unoccupied Dimmed Level	High Level (when occupied)	Phototcell Operation	Dwell Time	Ramp-up Time	Dimming Fade Rate				
PIR	30%	100%	Enabled @ 2FC	7.5 min	3 sec	5 min				
NLTAIR2 PIRHN	30%	100%	Enabled @ 2FC	7.5 min	3 sec	5 min				

Controls Options							
Nomenclature	Description	Functionality	Primary control device	Notes			
FAO	Field adjustable output device installed inside the luminaire; wired to the driver dimming leads.	Allows the luminaire to be manually dimmed, effectively trimming the light output.	FAO device	Cannot be used with other controls options that need the 0-10V leads			
DS (not available on DSX0)	Drivers wired independently for 50/50 luminaire operation	The luminaire is wired to two separate circuits, allowing for 50/50 operation.	Independently wired drivers	Requires two separately switched circuits. Consider nLight AIR as a more cost effective alternative.			
PER5 or PER7	Twist-lock photocell receptacle	Compatible with standard twist-lock photocells for dusk to dawn operation, or advanced control nodes that provide 0-10V dimming signals.	Twist-lock photocells such as DLL Elite or advanced control nodes such as ROAM.	Pins 4 & 5 to dimming leads on driver, Pins 6 & 7 are capped inside luminaire. Cannot be used with other controls options that need the 0–10V leads.			
PIR	Motion sensor with integral photocell. Sensor suitable for 8' to 40' mounting height.	Luminaires dim when no occupancy is detected.	Acuity Controls rSBG	Cannot be used with other controls options that need the 0-10V leads.			
NLTAIR2 PIRHN	nLight AIR enabled luminaire for motion sensing, photocell and wireless communication.	Motion and ambient light sensing with group response. Scheduled dimming with motion sensor over-ride when wirelessly connected to the nLight Eclypse.	nLight Air rSBG	nLight AIR sensors can be programmed and commissioned from the ground using the CIAIRity Pro app. Cannot be used with other controls options that need the 0-10V leads.			
BL30 or BL50	Integrated bi-level device that allows a second control circuit to switch all light engines to either 30% or 50% light output	BLC device provides input to 0-10V dimming leads on all drivers providing either 100% or dimmed (30% or 50%) control by a secondary circuit	BLC UVOLT1	BLC device is powered off the 0-10V dimming leads, thus can be used with any input voltage from 120 to 480V			

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Accessories

DLL127F 1.5 JU Photocell - SSL twist-lock (120-277V) <sup>25</sup> DLL347F 1.5 CUL JU Photocell - SSL twist-lock (347V) 25 DLL480F 1.5 CUL JU Photocell - SSL twist-lock (480V) 25

**Ordering Information** 

DSHORT SBK Shorting cap 25 DSX1HS P# House-side shield (enter package number 1-13 in place of #) DSXRPA (FINISH) Round pole adapter (#8 drilling, specify finish) DSXSPA5 (FINISH) Square pole adapter #5 drilling (specify finish) DSXRPA5 (FINISH) Round pole adapter #5 drilling (specify finish) DSX1EGSR (FINISH) External glare shield (specify finish) DSX1BSDB (FINISH) Bird spike deterrent bracket (specify finish)

NOTES

1 Rotated optics available with packages P10, P11, P12 and P13. Must be combined with option L90 or R90.

2 30K, 40K, and 50K available in 70CRI and 80CRI. 27K and 35K only available with 80CRI. Contact Technical Support for other possible combinations.

3 13LG, T4LG, BLC3, BLC4, LCCO, RCCO not available with option HS.

4 MVOLT driver operates on any line voltage from 120-277V (50/60 Hz).

5 HVOLT driver operates on any line voltage from 20-27V (50/60 Hz).

6 HVOLT not available with package P1 and P10 when combined with option NLTAIR2 PIRHN or option PIR.

7 XVOLT operates with any voltage between 277V and 480V (50/60 Hz).

8 XVOLT not available in packages P1 or P10. XVOLT not available with fusing (SF or DF).

9 SPAS and RPAS for use with #5 drilling only (Not for use with #8 drilling).

10 WBA cannot be combined with Type 5 distributions plus photocell (PER).

11 NLTAIR2 PIRHN must be ordered together. For more information on nLight AIR2 visit this link

12 NLTAIR2 PIRHN not available with other controls including PIR, PER, PER5, PER7, FAO, BL30, BL50, DMG and DS. NLTAIR2 PIRHN not available with P1 and P10 using XVOLT.

13 PIR not available with NLTAIR2 PIRHN, PER, PER5, PER7, FAO BL30, BL50, DMG and DS. PIR not available with P1 and P10 using HVOLT. PIR not available with P1 and P10 using AVOLT.

14 PER/PERS/PER7 not available with NLTAIR2 PIRHN, PIR, BL30, BL50, FAO, DMG and DS. Photocell ordered and shipped as a separate line item from Acuity Brands Controls. See accessories. Shorting Cap included.

15 FAO not available with other dimming control options NLTAIR2 PIRHN, PIR, PER5, PER7, BL30, BL50, DMG and DS.

16 BL30 and BL50 are not available with NLTAIR2 PIRHN, PIR, PER, PER5, PER7, FAO, DMG and DS.

17 DMG not available with NLTAIR2 PIRHN, PIR, PER, PER5, PER7, BL30, BL50, FAO and DS.

18 DS not available with NLTAIR2 PIRHN, PIR, PER, PER5, PER7, BL30, BL50, FAO and DMG.

19 DS requires (2) separately switched circuits. DS provides 50/50 fixture operation via (2) different sets of leads usin

23 CCE option not available with option BS and EGSR. Contact Technical Support for availability.
24 Option HA not available with performance packages P4, P5, P7, P8, P9 and P13.
25 Requires luminaire to be specified with PER7 potion. See Controls Table on page 4.
26 Single fuse (SF) requires 120V, 277V, or 347V. Double fuse (DF) requires 208V, 240V or 480V. XVOLT not available with fusing (SF or DF).

Shield Accessories



External Glare Shield (EGSR)

House Side Shield (HS)

**Tenon Mounting Slipfitter**  
 RPA
 AS3-5 190
 AS3-5 280
 AS3-5 290
 AS3-5 390
 AS3-5 320
 AS3-5 490

 RPA
 AST25-190
 AST25-280
 AST25-290
 AST25-390
 AST25-320
 AST25-490
 RPA AST35-190 AST35-280 AST35-290 AST35-390 AST35-320 AST35-490

		-		₹.	<u>. T.</u>	Y	-1-	
ounting Option	Drilling Template	Single	2 @ 180	2@90	3 @ 90	3 @ 120	4@90	
Head Location		Side B	Side B & D	Side B & C	Side B, C & D	Round Pole Only	Side A, B, C & D	
rill Nomenclature	#8	DM19AS	DM28AS	DM29AS	DM39AS	DM32AS	DM49AS	
			N	linimum Acceptable	Outside Pole Dimer	sion		
'A	#8	3.5"	3.5"	3.5"	3.5"		3.5"	
PA	#8	3"	3"	3"	3"	3"	3"	
A5	#5	3"	3"	3"	3"		3"	
PA5	#5	3"	3"	3"	3"	3"	3"	
'A8N	#8	3"	3"	3"	3"		3"	

DSX1 Area Luminaire - FPA

*Includes luminaire and integral mountin		ns, arms, brackets	or other accessorie	es are not included	d in this EPA data.	
Fixture Quantity & Mounting Configuration	Single DM19	2 @ 180 DM28	2 @ 90 DM29	3 @ 90 DM39	3 @ 120 DM32	4 @ 90 DM49
Mounting Type			₹_	<b>_</b> 7_	Y	
DSX1 with SPA	0.69	1.38	1.23	1.54		1.58
DSX1 with SPA5, SPA8N	0.70	1.40	1.30	1.66		1.68
DSX1 with RPA, RPA5	0.70	1.40	1.30	1.66	1.60	1.68
DSX1 with MA	0.83	1.66	1.50	2.09	2.09	2.09

LITHONIA LIGHTING. COMMERCIAL OUTDOOR

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ENGINEER INFORMATION:

STORE:

**RAISING CANE'S** 

RESTAURANT

494 LINCOLN ST. WORCESTER, MA 01605

PROTOTYPE: P6-V-Av SCHEME: B

RESTAURANT #RC1233

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SHEET REVISIONS # DATE TYPE

**EXTERIOR LIGHT** FIXTURE CUT SHEETS

10/1/2024 24164 JOB NO.


SHEET NO.


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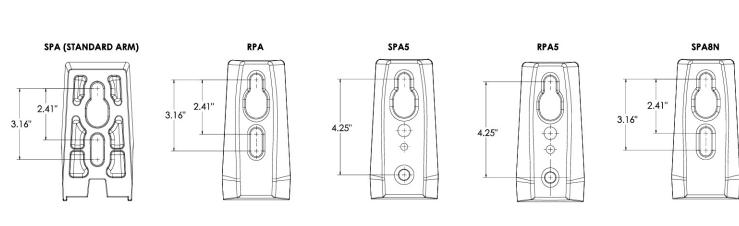
DSX1-LED Rev. 09/05/23 Page 3 of 10

COMMERCIAL OUTDOOR

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### FEATURES & SPECIFICATIONS

INTENDED USE — These specifications are for USA standards only. Square Straight Steel is a general purpose light pole for up to 39-foot mounting heights. This pole provides a robust yet cost effective option for mounting area lights and floodlights. CONSTRUCTION —

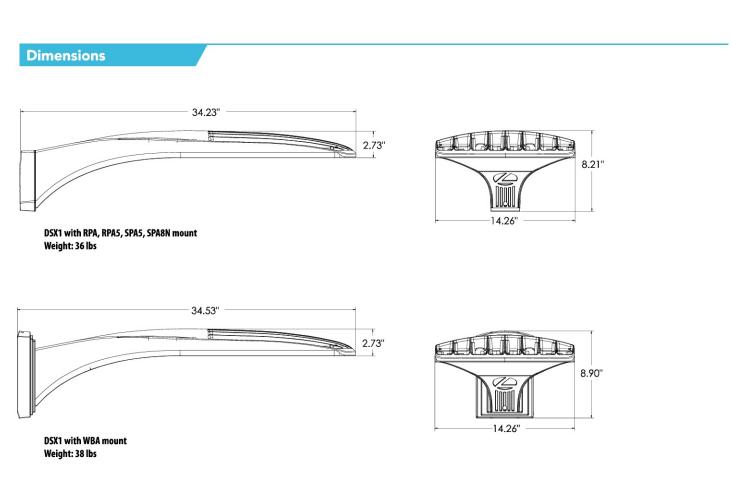Pole Shaft: The pole shaft is of uniform dimension and wall thickness and is made of a weldable-grade, hot-rolled, commercial-quality steel tubing with a minimum yield of 55 KSI (11-gauge, 0.120"), or 50 KSI (7-gauge, 0.179"). Shaft is one-piece with a full-length longitudinal high-frequency electric resistance weld. Uniformly square in crosssection with flat sides, small corner radii and excellent torsional qualities. Available shaft widths are 4", 5" and 6". **Pole Top:** Options include tenon top, drilled for side mount fixture, tenon with drilling (includes extra handhole) and open top. Side drilled and open top poles include a removable top cap.

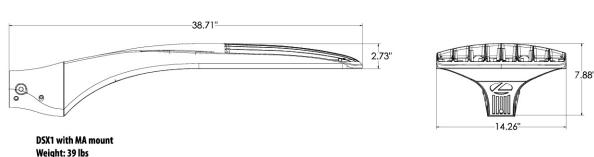Handhole: A reinforced handhole with grounding provision is provided at 18" from the base on side A. Positioning the handhole lower may not be possible and requires engineering review; consult Tech Support-Outdoor for further information. Every handhole includes a cover and cover attachment hardware. The handhole has a nominal dimension of 2.5" x 5".

Base Cover: A durable ABS plastic two-piece full base cover, finished to match the pole, is provided with each pole assembly. Additional base cover options are available upon request.

to ASTM F1554 Standards grade 55, (55 KSI minimum yield strength and tensile strength of 75-95 KSI). Top threaded portion (nominal 12") is hot-dipped galvanized per ASTM A-153.  $\textbf{HARDWARE} \ -- \ \text{All structural fasteners are high-strength galvanized carbon steel}. \ \text{All non-structural fasteners are}$ 

Anchor Base/Bolts: Anchor base is fabricated from steel that meets ASTM A36 standards and can be altered to match existing foundations; consult factory for modifications. Anchor bolts are manufactured

galvanized or zinc-plated carbon steel or stainless steel. FINISH — Extra durable painted finish is coated with TGIC (Triglycidyl Isocyanurate) Polyester powder that meets 5A and 5B classifications of ASTM D3359. Powder-coat finishes include Dark Bronze, White, Black, and Natural


Aluminum colors. Architectural Colors and Special Finishes are available by quote and include, but are not limited


to Paint over Hot-dipped Galvanized, RAL Colors, Custom Colors and Extended Warranty Finishes. **BUY AMERICAN** — Product with the BAA option is assembled in the USA and meets the Buy America(n) government procurement requirements under FAR, DFARS and DOT. Please refer to www.acuitybrands.com/ buy-american for additional information.

**INSTALLATION** — **Do not** erect poles without having fixtures installed. Factory-supplied templates must be used when setting anchor bolts. Lithonia Lighting will not accept claim for incorrect anchorage placement due to failure to use Lithonia Lighting factory templates. If poles are stored outside, all protective wrapping must be removed immediately upon delivery to prevent finish damage. Lithonia Lighting is not responsible for the foundation design.

**WARRANTY** — 1-year limited warranty. This is the only warranty provided and no other statements in this specification sheet create any warranty of any kind. All other express and implied warranties are disclaimed. Complete warranty terms located at: <a href="https://www.acuitybrands.com/support/warranty/terms-and-conditions">www.acuitybrands.com/support/warranty/terms-and-conditions</a> **NOTE**: Actual performance may differ as a result of end-user environment and application. Specifications subject to change without notice.

OUTDOOR

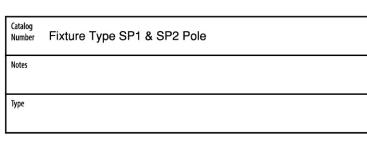


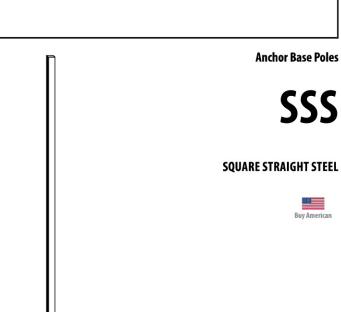


### nLight Control - Sensor Coverage and Setting

nLight Sensor Coverage Pattern



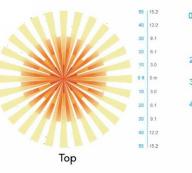

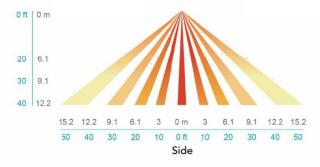

### **FEATURES & SPECIFICATIONS**

The sleek design of the D-Series Size 1 reflects the embedded high performance LED technology. It is ideal for many commercial and municipal applications, such as parking lots, plazas, campuses, and streetscapes. CONSTRUCTION

Single-piece die-cast aluminum housing has integral heat sink fins to optimize thermal management through conductive and convective cooling. Modular design allows for ease of maintenance and future light engine upgrades. The LED drivers are mounted in direct contact with the casting to promote low operating temperature and long life. Housing driver compartment is completely sealed against moisture and environmental contaminants (IP66). Vibration rated per ANSI C136.31 for 3G for SPA and MA. 1.5G for mountings RPA, RPA5, SPA5 and SPA8N. Low EPA (0.69 ft<sup>2</sup>) for optimized pole wind loading.

## Exterior parts are protected by a zinc-infused Super Durable TGIC thermoset powder coat finish that provides superior resistance to corrosion and weather-

ing. A tightly controlled multi-stage process ensures a minimum 3 mils thickness for a finish that can withstand extreme climate changes without cracking or peeling. Available in both textured and non-textured finishes. Coastal Construction (CCE)

Optional corrosion resistant construction is engineered with added corrosion protection in materials and/or pre-treatment of base material under super durable paint. Provides additional corrosion protection for applications near coastal areas. Finish is salt spray tested to over 5,000 hours per ASTM B117 with scribe rating of 10. Additional lead-times may apply.

Precision-molded proprietary silicone lenses are engineered for superior area lighting distribution, uniformity, and pole spacing. Light engines are available in standard 3000 K, 4000 K and 5000 K (70 CRI) configurations. 80CRI configurations are also available. The D-Series Size 1 has zero uplight and qualifies as a Nighttime Friendly™ product, meaning it is consistent with the LEED® and Green Globes™ criteria for eliminating wasteful uplight. ELECTRICAL

Light engine configurations consist of high-efficacy LEDs mounted to metalcore circuit boards to maximize heat dissipation and promote long life (up to L81/100,000 hours at 25°C). Class 1 electronic drivers are designed to have a power factor >90%, THD <20%, and an expected life of 100,000 hours with <1% failure rate. Easily serviceable 10kV surge protection device meets a minimum Category C Low operation (per ANSI/IEEE C62.41.2).

### STANDARD CONTROLS

LITHONIA

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LIGHTING.

The DSX1 LED area luminaire has a number of control options. DSX Size 1, comes standard with 0-10V dimming drivers. Dusk to dawn controls can be utilized via optional NEMA twist-lock photocell receptacles. Integrated motion sensor with on-board photocells feature field-adjustable programing and are suitable for mounting heights up to 40 feet. Control option BL features a bi-level device that allows a second control circuit to switch all light engines to either

### nLIGHT AIR CONTROLS

The DSX1 LED area luminaire is also available with nLight® AIR for the ultimate in wireless control. This powerful controls platform provides out-of-the-box basic motion sensing and photocontrol functionality and is suitable for mounting heights up to 40 feet. Once commissioned using a smartphone and the easy-touse CLAIRITY app, nLight AIR equipped luminaries can be grouped, resulting in motion sensor and photocell group response without the need for additional equipment. Scheduled dimming with motion sensor over-ride can be achieved when used with the nLight Eclypse. Additional information about nLight Air can

Integral mounting arm allows for fast mounting using Lithonia standard #8 drilling and accommodates pole drilling's from 2.41 to 3.12" on center. The standard "SPA" option for square poles and the "RPA" option for round poles use the #8 drilling. For #5 pole drillings, use SPA5 or RPA5. Additional mountings are available including a wall bracket (WBA) and mast arm (MA) option that allows luminaire attachment to a 2 3/8" horizontal mast arm.

UL listed to meet U.S. and Canadian standards. UL Listed for wet locations. Light engines are IP66 rated; luminaire is IP66 rated. Rated for -40°C minimum

DesignLights Consortium® (DLC) Premium qualified product and DLC qualified product. Not all versions of this product may be DLC Premium qualified or DLC qualified. Please check the DLC Qualified Products List at www.designlights.org/ QPL to confirm which versions are qualified.

International Dark-Sky Association (IDA) Fixture Seal of Approval (FSA) is available for all products on this page utilizing 3000K color temperature only.

Product with the BAA option is assembled in the USA and meets the Buy America(n) government procurement requirements under FAR, DFARS and DOT regulations. Please refer to www.acuitybrands.com/buy-american for additional

5-year limited warranty. This is the only warranty provided and no other statements in this specification sheet create any warranty of any kind. All other express and implied warranties are disclaimed. Complete warranty terms located

Note: Actual performance may differ as a result of end-user environment and application. All values are design or typical values, measured under laboratory conditions at 25 °C. Specifications subject to change without notice.

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## Rev. 09/05/23 Page 10 of 10

### **SSS** Square Straight Steel Poles

SSS	20'-0"	5G	DM19AS				DDBX	)
Series	Nominal fixture mounting height	Nominal shaft base size/wall thickness <sup>2</sup>	Mounting <sup>3</sup>		Options		Finish <sup>14</sup>	
SSS1	10'-39' (for 1/2 ft increments, add -6 to the pole height. Ex: 20-6 equals 20ft 6in.)  See technical information table for complete ordering information.)	4C 4" 11g (0.120") 4G 4" 7g (0.179") 5C 5" 11g (0.120") 5G 5" 7g (0.179") 6G 6" 7g (0.179") See technical information table for complete ordering information.)	Tenon mounting PT	AERIS™ Suspend drill mounting <sup>4,6</sup> DM19AST_ 1 at 90° DM29AST_ 2 at 180° DM39AST_ 3 at 90° DM49AST_ 4 at 90° OMERO™ Suspend drill mounting <sup>4,6</sup> DM19MRT_ 1 at 90° DM28MRT_ 2 at 180° DM29MRT_ 2 at 90° DM39MRT_ 3 at 90° DM49MRT_ 4 at 90°	,	Vibration damper <sup>7</sup> Horizontal arm bracket (1 fixture) <sup>8,9</sup> Festoon outlet less electrical <sup>8,10</sup> 1/2" coupling <sup>8</sup>	DDBXD DBLXD DNAXD DWHXD DDBTXD DBLBXD DNATXD  DWHGXD Other finit GALV Architectt finishes Paint over	able paint colors Dark bronze Black Natural aluminum White Textured dark bron Textured black Textured natural aluminum Textured white shes Galvanized finish ural colors and specia Falvanized, RAL Cololors and Extended Finishes available.

## 1. Handhole covers (HHC), full base covers (FBC) and top caps (TC) shipped separately. No need to call out in nomenclature.

- For additional parts please order as replacements 2. Wall thickness will be signified with a "C" (11 Gauge) or a "G" (7-Gauge) in nomenclature. "C" - 0.120" | "G" - 0.179".
- 3. PT open top poles include top cap. When ordering tenon mounting and drill mounting for the same pole, follow this example: DM28/T20. The combination includes a required extra handhole. 4. Refer to the fixture spec sheet for the correct drilling template pattern
- and orientation compatibility. 5. All RAD drilling's require a minimum top O.D. of 4".
- 6. Insert "1" or "2" to designate fixture size; e.g. DM19AST2.
- 7. On 4" and 5" poles, VD cannot be installed if provisions (EHH, FDL, NPL, CPL) are located higher than 2/3 of the pole's
- Example: Pole height is 25ft, A provision cannot be placed above 16ft.
- 8. Specify location and orientation when ordering option. For "x": Specify the height above the base of pole in feet or feet and inches; separate feet and inches with a "-". Example: 5ft = 5 and 20ft 3in = 20-3For "y": Specify orientation from handhole (A,B,C,D) Refer to the Handhole Orientation diagram below.

Example: 1/2" coupling at 5'8", orientation C = CPL12/5-8C

- 9. Horizontal arm is 18" x 2-3/8" 0.D. tenon standard, with radius curve providing 12" rise and 2-3/8" 0.D. If ordering two horizontal arm at the same height, specify with HAxyy. Example: HA20BD. 10. FDL does not come with GFCI outlet or handhole cover. These must be supplied by contractor or electrician. 11. Combination of tenon-top and drill mount includes extra handhole. EHH includes cover. 12. Provides enhanced corrosion resistance.
- 13. Use when mill certifications are required. 14. Finish must be specified. Additional colors available; see Architectural Colors brochure linked here (Form No. 794.3).

### Accessories: Order as separate catalog number. PL DT20 Plugs for ESX drillings


PL DT8 Plugs for DMxxAS drillings

## **LITHONIA LIGHTING**

### **SSS** Square Straight Steel Poles

Catalog Number	Nominal Shaft Length (ft.)*	Pole Shaft Size (Base in. x Top in. x ft.)	Wall thick (in)		EPA (ft²) with 1.3 gust							Approximate	
				Gauge	80 MPH	Max. weight	90 MPH	Max. weight	100 MPH	Max. weight	Bolt circle (in)	Bolt size (in. x in. x in.)	ship weight (lbs.)
SSS 10 4C	10	4.0 x 10.0	0.120"	11	30.6	765	23.8	595	18.9	473	89	3/4 x 18 x 3	75
SSS 12 4C	12	4.0 x 12.0	0.120"	11	24.4	610	18.8	470	14.8	370	89	3/4 x 18 x 3	90
SSS 14 4C	14	4.0 x 14.0	0.120"	11	19.9	498	15.1	378	11.7	293	89	3/4 x 18 x 3	100
SSS 16 4C	16	4.0 x 16.0	0.120"	11	15.9	398	11.8	295	8.9	223	89	3/4 x 18 x 3	115
SSS 18 4C	18	4.0 x 18.0	0.120"	11	12.6	315	9.2	230	6.7	168	89	3/4 x 18 x 3	125
SSS 20 4C	20	4.0 x 20.0	0.120"	11	9.6	240	6.7	167	4.5	150	89	3/4 x 18 x 3	140
SSS 20 4G	20	4.0 x 20.0	0.179"	7	14	350	11	275	8	200	89	3/4 x 30 x 3	198
SSS 20 5C	20	5.0 x 20.0	0.120"	11	17.7	443	12.7	343	9.4	235	1012	1 x 36 x 4	185
SSS 20 5G	20	5.0 x 20.0	0.179"	7	28.1	703	21.4	535	16.2	405	1012	1 x 36 x 4	265
SSS 25 4C	25	4.0 x 25.0	0.120"	11	4.8	150	2.6	100	1	50	89	3/4 x 18 x 3	170
SSS 25 4G	25	4.0 x 25.0	0.179"	7	10.8	270	7.7	188	5.4	135	89	3/4 x 30 x 3	245
SSS 25 5C	25	5.0 x 25.0	0.120"	11	9.8	245	6.3	157	3.7	150	1012	1 x 36 x 4	225
SSS 25 5G	25	5.0 x 25.0	0.179"	7	18.5	463	13.3	333	9.5	238	1012	1 x 36 x 4	360
SSS 30 4G	30	4.0 x 30.0	0.179"	7	6.7	168	4.4	110	2.6	65	89	3/4 x 30 x 3	295
SSS 30 5C	30	5.0 x 30.0	0.120"	11	4.7	150	2	50	-	_	1012	1 x 36 x 4	265
SSS 30 5G	30	5.0 x 30.0	0.179"	7	10.7	267	6.7	167	3.9	100	1012	1 x 36 x 4	380
SSS 30 6G	30	6.0 x 30.0	0.179"	7	19	475	13.2	330	9	225	1113	1 x 36 x 4	520
SSS 35 5G	35	5.0 x 35.0	0.179"	7	5.9	150	2.5	100			1012	1 x 36 x 4	440
SSS 35 6G	35	6.0 x 35.0	0.179"	7	12.4	310	7.6	190	4.2	105	1113	1 x 36 x 4	540
SSS 39 6G	39	6.0 x 39.0	0.179"	7	7.2	180	3	75			1113	1x36x4	605

### NOTE: \* EPA values are based ASCE 7-93 wind map. For 1/2 ft increments, add -6 to the pole height. Ex: 20-6 equals 20ft 6in.

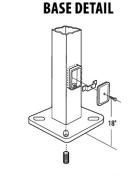

POLE DATA									
Shaft base size	Bolt circle A	Bolt projection B	Base square C	Base plate thickness	Template description	Anchor bolt description	Anchor bolt and template description		
4"C	8" – 9"	3.25"- 3.75"	8"- 8.25"	0.75"	ABTEMPLATE PJ50004	AB18-0	ABSSS-4C		
4"G	8" – 9"	3.38"- 3.75"	8"- 8.25"	0.875"	ABTEMPLATE PJ50004	AB30-0	ABSSS-4G		
5"	10" – 12"	3.5"- 4"	11"	1"	ABTEMPLATE PJ50010	AB36-0	ABSSS-5		
6"	11" – 13"	4"- 4.50"	12.5"	1"	ABTEMPLATE PJ50011	AB36-0	N/A		



# IMPORTANT INSTALLATION NOTES: HANDHOLE ORIENTATION

# factory templates.

### • Do not erect poles without having fixtures installed. • Factory-supplied templates must be used when setting anchor bolts. Lithonia Lighting will not accept claim for incorrect anchorage placement due to failure to use Lithonia Lighting

• If poles are stored outside, all protective wrapping must be removed immediately upon delivery to prevent finish damage. • Lithonia Lighting is not responsible for the foundation design.

Bolt circles have +/- 1/2" tolerance.

CAUTION: These specifications are intended for general purposes only. Lithonia Lighting reserves the right to change material or design, without prior notice, in a continuing effort to upgrade its products.

POLE-SSS **LITHONIA LIGHTING** 

STORE:

**RAISING CANE'S** RESTAURANT 494 LINCOLN ST. WORCESTER, MA 01605 PROTOTYPE: P6-V-Av SCHEME: B

RESTAURANT #RC1233

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**EXTERIOR LIGHT** FIXTURE CUT SHEETS

10/1/2024 24164 JOB NO.

POLE-SSS

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